

#### LEGAL DESCRIPTION:

This is to cartify to TCF National Bank, Roseville Crossing LLC, Chicago Title Insurance Company, Land Title, Inc., Commercial Panners Title, LLC as agent for First American Title Insurance Company, that this majo or clies and the survey on which it is based were made in accordance with the "Minimum Standard Debal Requirements for ALTA/ACSM Land Title Surveys' (only established and adopted by ALTA, ACSM and NSPS in 2005 and includes from 1, 2, 3, 4 (16), 17b) (17), 18, 9, 10 and 11 but Table A heaved, Pursuant to the Accuracy Standards as adopted by ALTA and NSPS and in effect on the defo of this cartification, undersigned further cartifies that in my professional opinion, as a Land Surveyor Econsed in the State of Minnesota, the Relative Positional Accuracy of this survey does not exceed that which I specified therein.

Advances of the Survey does not exceed that which I specified therein.

Dates.

Kénneth I. Whitehom Minnesote License No. 14677

- The area of the property described above is 28.877 square feet or 0.6629 acros.
- 7. There are 14 parking spaces including 1 handican space.
- The property lies in an area not mapped in a flood hazard zone according to the Federal Emergency Management Agency Flood Insurance Rate Map Community Panel No. 270599.

#### SCHEDULE B - SECTION TWO EXCEPTIONS:

- item 10 Right of Tenants under unrecorded leases cannot be picted

#### SCHEDULE B - SECTION TWO EXCEPTIONS:

- Item 7. Taxes or special assessments cannot be plotted
- Item 8 General or special lares and assessments cannot be plotte
- Item 10 To be removed.
- Item 11 Mortgages, Document No. 3926554, cannot be plotted
- Item 12 Construction Indemnities cannol be plotted.


Top nut of hydrant (TNH) located 52 feet westerly of the centerline of Lexington Ave North and 24 feet northerly of the centerline of Sandhurst Drive.


ALTA/ACSM LAND TITLE SURVEY

2167 LEXINGTON AVENUE NORTH ROSEVILLE, MINNESOTA

📆 Engineers - Surveyor Landscape Architects

Project No. 06-091A Drawn by JDB Checked by D. T. Book/Page 156/11 Client: Wellington

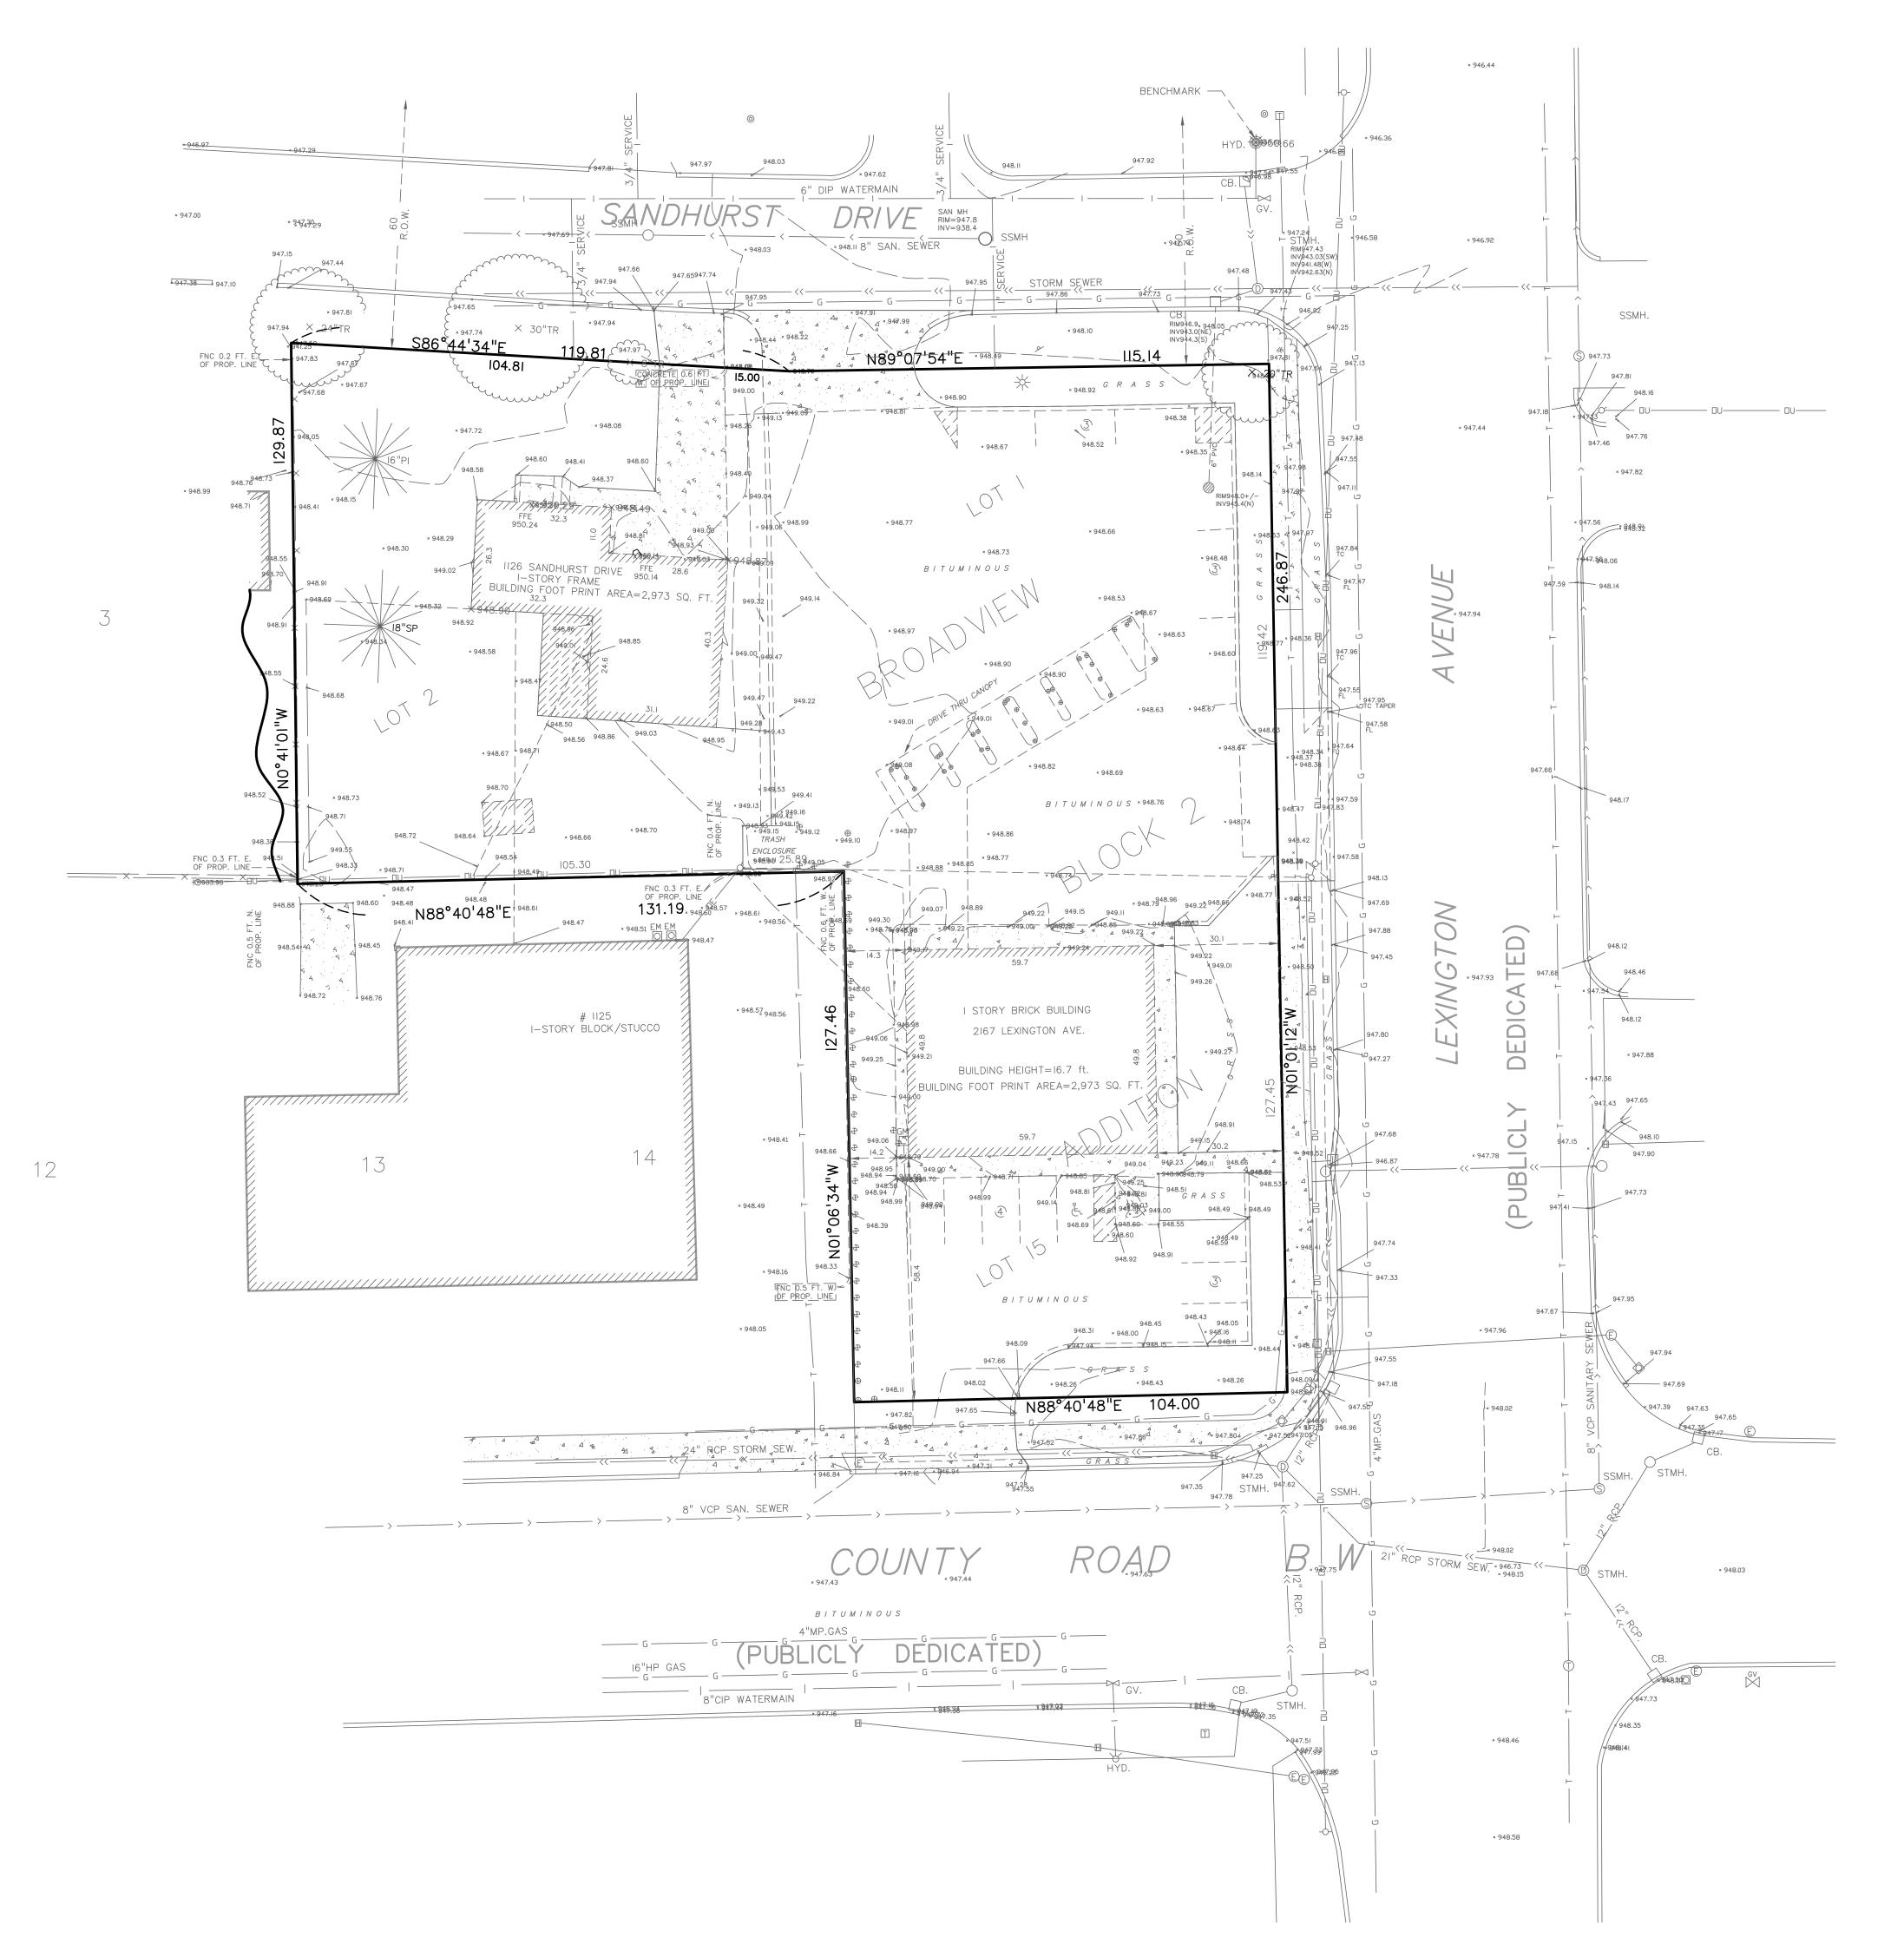

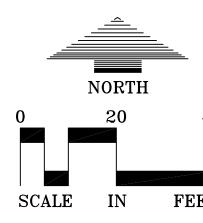

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#### EXISTING CONDITIONS GENERAL NOTES

- I. The information shown on this Existing Conditions Plan was prepared from a ALTA/ACSM Land Title Survey prepared by Hansen Thorp Pellinen Olson Inc. and dated 12-26-06 & 3-29-07. Utility information shown on this plan, such as Sanitary Sewer, Watermain, Storm Sewer, Forcemain, Etc. was provided by the City of Roseville Record Plans. Utility information shown on this plan, such as Natural Gas, Electric Lines, Telephone Lines, Fiberoptic Lines, Cable Television Lines, Underground Pipelines, etc. was from the ALTA/ACSM Land Title Survey.
- 2. The geotechnical and soils information shown on this plan was provided by \_\_\_\_\_\_\_\_. report dated \_\_\_\_\_\_\_\_\_\_.
- 3. We have shown buried structures and utilities on and/or serving the site to the best of our ability, subject to the following restrictions:

  a. Utility operators do not consistently respond to lacate requests through the
- Gopher State One Call service for boundary and location purposes such as this.

  b. Those utility operators that do respond, often will not locate services from the main line to the customer's structure or facility they consider those segments private installations that are outside of their jurisdiction. If a private service to an adjoiner's site crosses this site or a service to this site crosses an adjoiner, it may not be located since most operators will not mark such "private" services.
- Snow and ice conditions during winter months may obscure otherwise visible evidence of a buried structure or utility.
- d. Maps provided by utility operators, either along with a field location or in lieu of such a location, are very often inaccurate or inconclusive. Maps provided by utility operators are very often at a very small scale, or no scale.
- e. Extreme caution must be exercised before an excavation takes place on or near the site. Before digging, you are required by law to notify GOPHER STATE ONE CALL at least 48 hours in advance at 651—454—0002.



# CALL BEFORE YOU DIG! Gopher State One Call TWIN CITY AREA: 651-454-0002

TWIN CITY AREA: 651-454-0002 TOLL FREE: I-800-252-1166

### WARNING:

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Project Name:


Rosevi

Roseville Crossing

Roseville, Minnesota

Roseville Crossing LLC. C/O Wellington Management, Inc.

1625 Energy Park Drive, Suite 100
St.Paul, Minnesota 55108
Ph.651-292-9844 Fax.651-292-0072

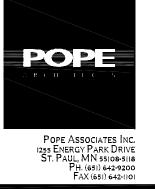

Professional Services

## ASSOCIATES

Planning • Civil Engineering • Land Surveying Landscape Architecture • Environmental

> 7200 Hemlock Lane - Suite 300 Minneapolis, Minnesota 55369 Telephone: (763)424-5505 Fax: (763)424-5822 www.LoucksAssociates.com

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C08261-1-1.DWG/Layout1

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Sub	mitta	l:

2-06-09	City Submittal
2-25-09	Rev. City Submittal
3-16-09	Revised City Submittal
4-29-09	Revised Building & Layout

Professional Signature:

I hereby certify that this plan, specification or report was

prepared by me or under my direct supervision and that I am a duly Licensed Professional Engineer under the laws of the State of Minnesota.

	Eric Beazley - PE	
12010	,	

Quality Control:	
FW/R	W

i roject Lead.		Diawii by.	
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Checked By:		Review Date:	

Checked By:	Review Date:
Sheet Index:	

<u>C0-1</u>	Cover Sheet
C1-1	Existing Conditions Plan
C1-2	Demolition Plan
C2-1	Site Plan

C2-1	Site Plan
C3-1	Grading and Drainage Plan
C3-2	Storm Water Pollution Prevention Plan
C4-1	Utility Plan
C8-1 C8-2	Litility Details

C8-1, C8-2 Utility Plan

C8-1, C8-2 Utility Details

L1-1 Landscape Plan

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Sheet Title:


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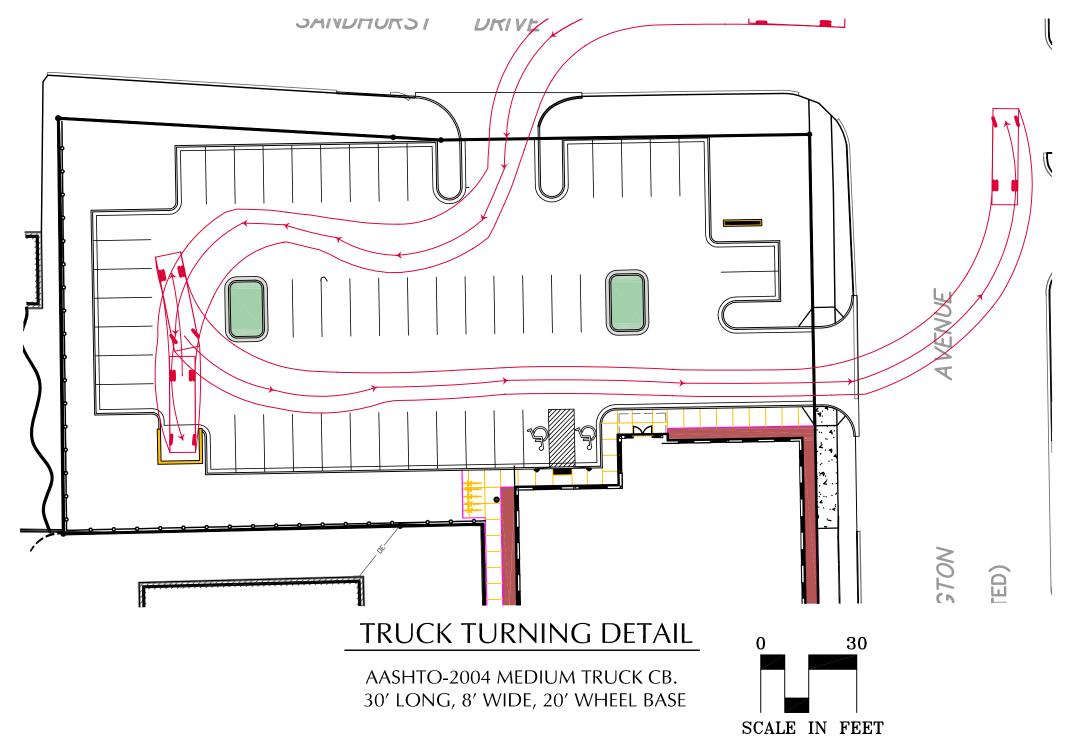
Existing Conditions Plan


Project No.:

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#### SITE PLAN GENERAL NOTES

	SHEP	LAN GE	NERAL NOTES	
l.	SETBACKS: Front building setback = Side building setback = Rear building setback =	30' 10' 20'	Front parking setback = Side parking setback = Rear rear setback =	15' 10' 5'
2.	ZONING Existing zoning Lot I = Existing zoning Lot 2 =	B3 RI	Proposed zoning Lot I= Proposed zoning Lot 2=	B3 RI
3.	PARKING SUMMARY Regular stalls =	46	Handicapped stalls =	2

- Total Property Area = 42,062 Sq.Ft. or 0.97 Ac. = 100%

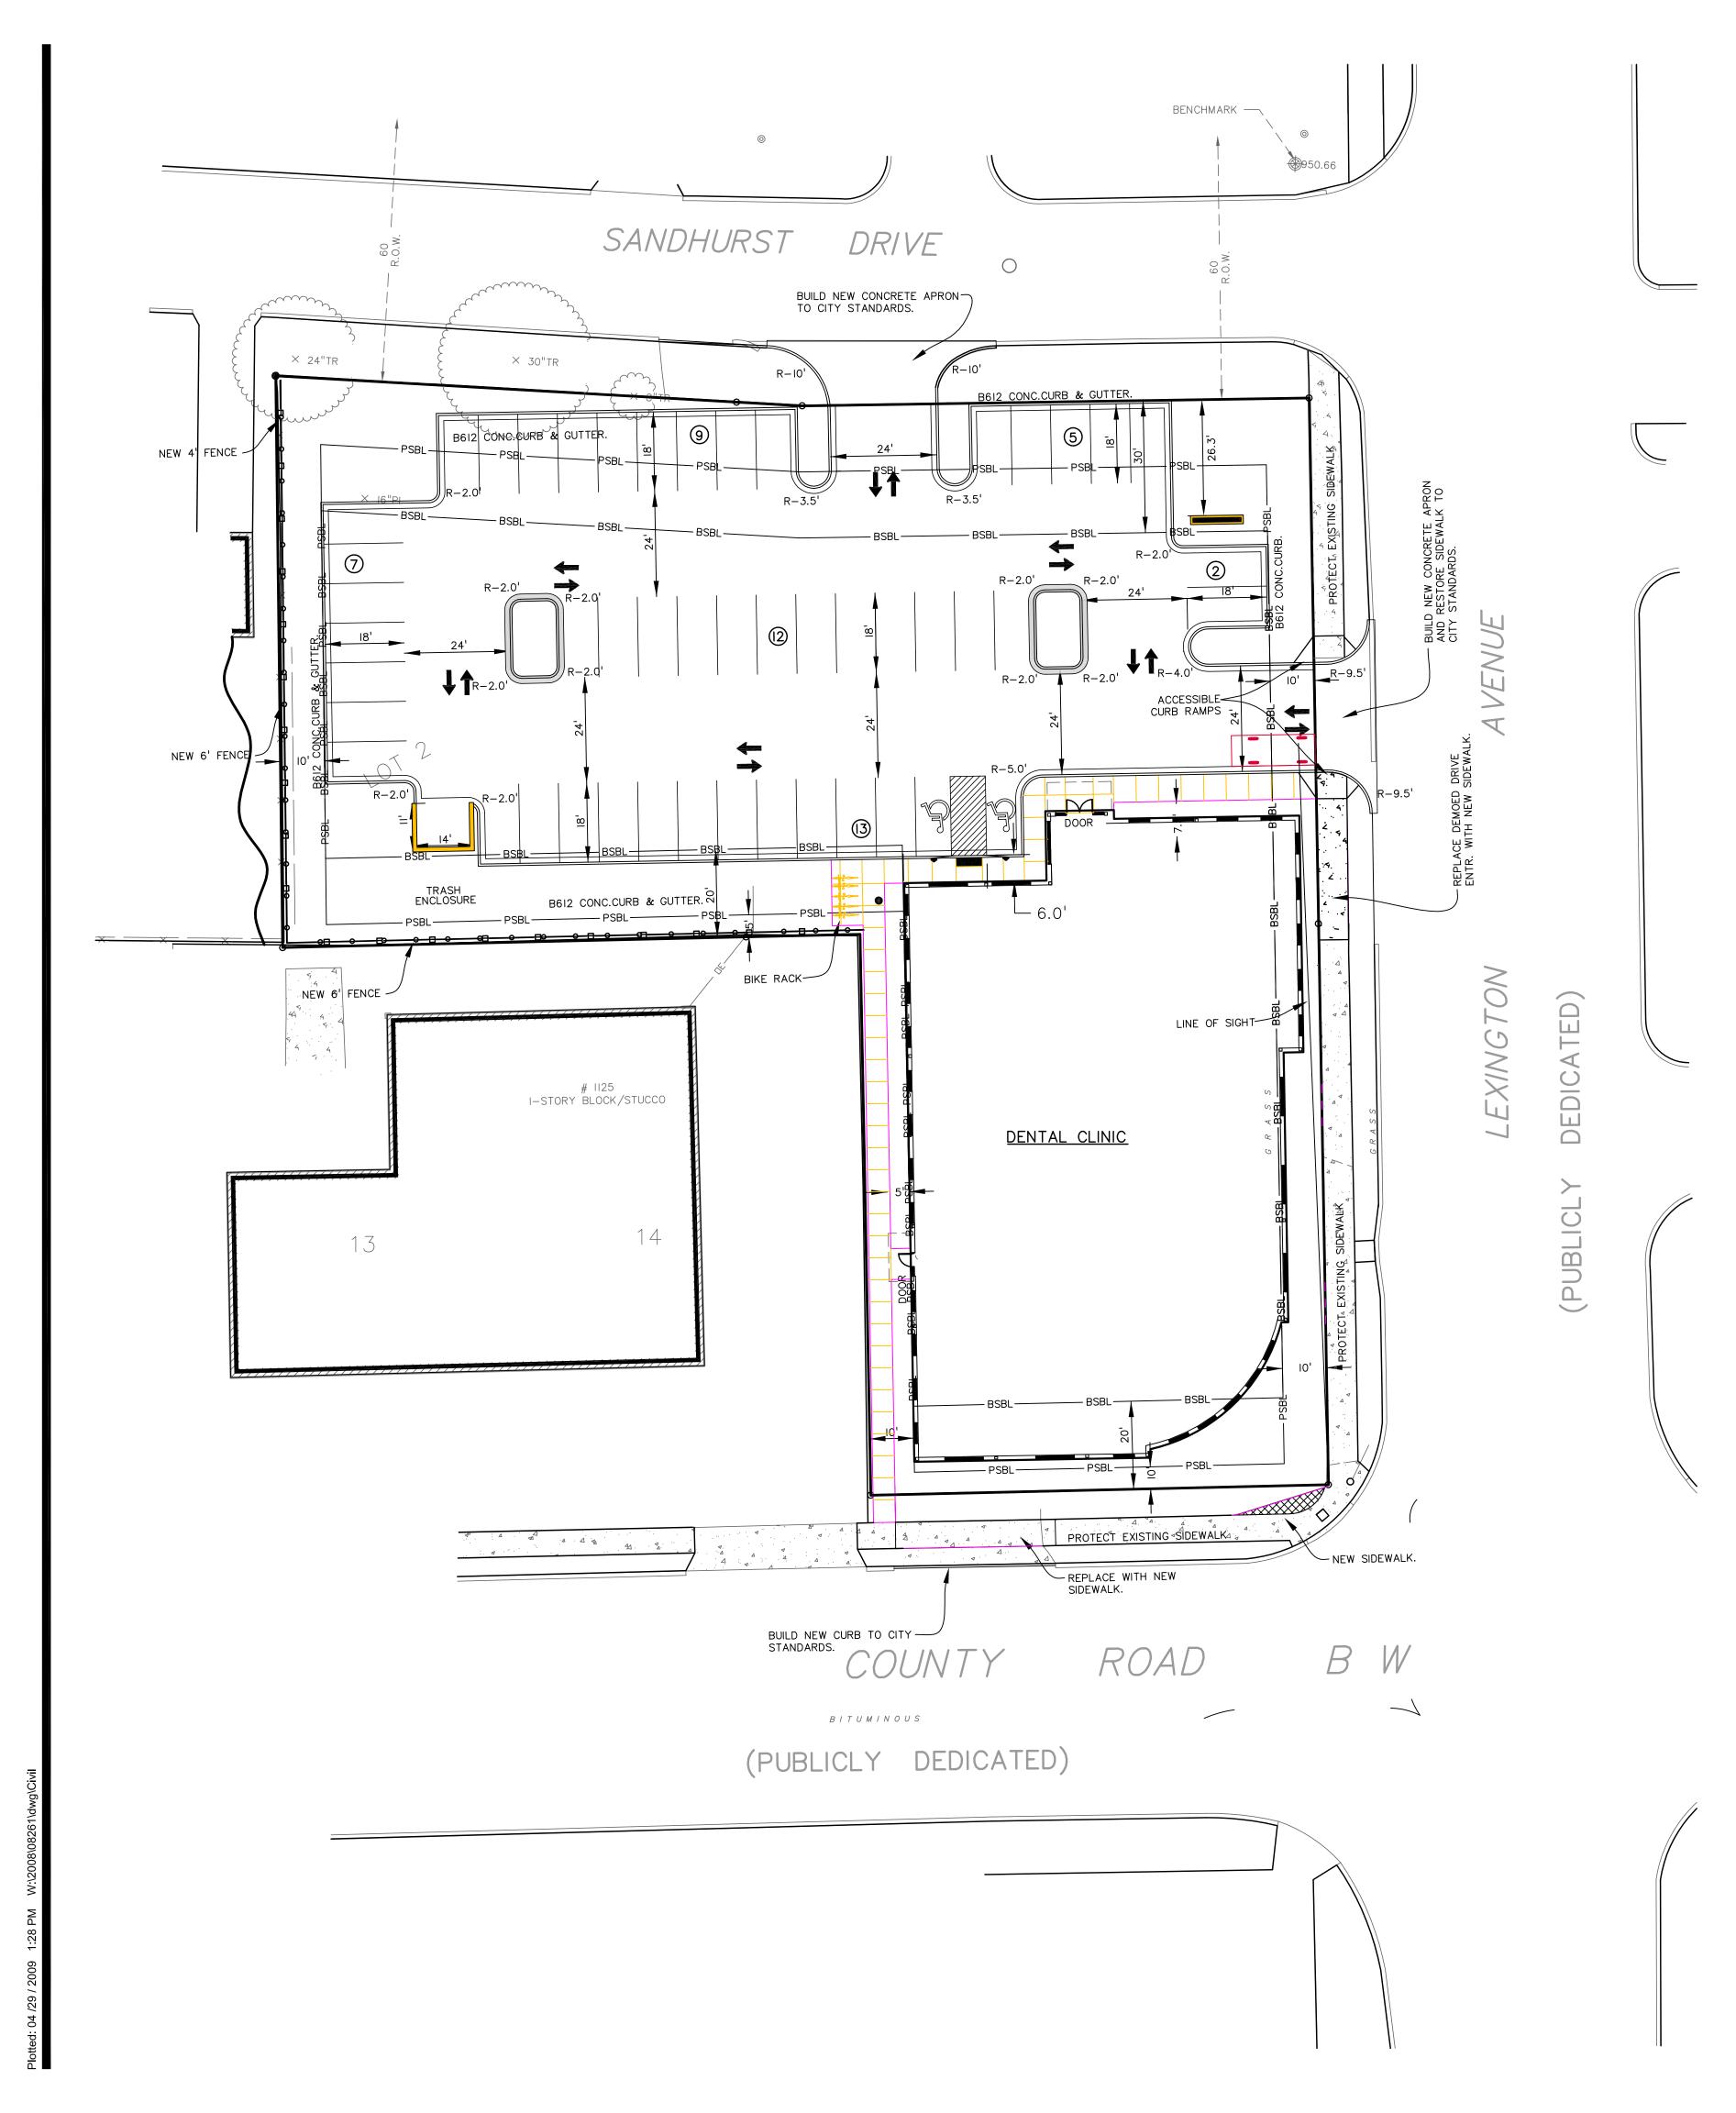  Impervious Surface Area = 32,680 Sq.Ft. or 0.75 Ac. = 77.0%

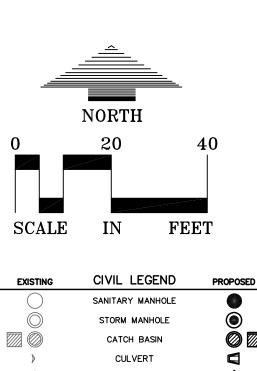  Pervious Surface Area = 9,382 Sq.Ft. or 0.22 Ac. = 23%
- 5. All paving, concrete curb, gutter and sidewalk shall be furnished and installed in accordance with the details shown per sheet C8—I and the requirements of the City. See Landscape and Architectural Plans for any additional hardscape applications.
- The City Department of Engineering and Building Inspections Dept. and the construction engineer shall be notified at least 48 hours prior to any work within the street right of way (sidewalk, street or driveways)
- 7. Minnesota State statute requires notification per "Gopher State One Call" prior to commencing any grading, excavation or underground work.
- 8. See contract specifications for any removal details.
- 9. Any sign or fixtures removed with in the right of way or as part of the site work shall be replaced by the contractor in accordance with the City requirements. The contractor shall preserve and maintain any existing street lights and traffic signs per the requirements of the City.
- 10. Clear and grub and remove all trees, vegetation and site debris prior to grading. All removed material shall be hauled from the site daily. All clearing and grubbing and removals shall be performed per the contract specifications. Erosion control measures shall be immediately established upon removal. (See Sheet C3-I)
- II. The contractor shall be required to obtain all permits from the City as required for all work with the street and public right of way.
- 12. A significant portion of site improvements not shown on this sheet are described and provided in further detail on the Architectural and Landscape Plans. This includes landscaping, lighting and other fixtures.
- 13. B612 concrete curb and gutter shall be installed at the edge of all common drives and parking lots. The curb shall be tapered and dropped across individual driveway entrances.
- 14. Construction Notes:
  - Pedestrian ramps shall be provided at the locations shown and as shown per the landscape site plans.
- 15. See Sheets C3—I and C4—I for grading and utilities.
- 16. All concrete curb and gutter B612, City's Standard Plates. (See Detail Sheet).
- General Contractor will need a Ramsey County Entrance Permit. Contact Dennis Hagle at 651-248-0453.



Gopher State One Call

TWIN CITY AREA: 651-454-0002
TOLL FREE: 1-800-252-1166

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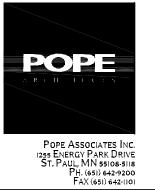
Rosevil

Roseville Crossing

Roseville, Minnesota

Roseville Crossing LLC.
C/O Wellington Management, Inc.

1625 Energy Park Drive, Suite 100
St.Paul, Minnesota 55108
Ph.651-292-9844 Fax.651-292-0072



rofessional Services

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C08261-2-1.DWG/Layout1

## Submittal:

-00-07	City Submittal	
-25-09	Rev. City Submittal	
-16-09	Revised City Submittal	
-29-09	Revised Building & Layout	

Professional Signature:

I hereby certify that this plan, specification or report was prepared by me or under my direct supervision and that I am a duly Licensed Professional Engineer under the laws of the State of Minnesota.

	Eric Beazley - PE	
43912		
License No		

Quality Control:

WRP
Project Lead: Drawn By:

Checked By: Review Date:

Sheet Index:

C0-1 Cover Sheet

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C1-1 Existing Conditions Plan
C1-2 Demolition Plan
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C8-1, C8-2 Utility Details

Landscape Plan

Sheet Title:


Site Plan


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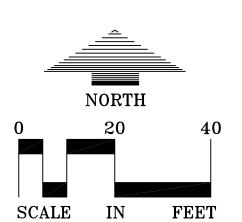
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C2-





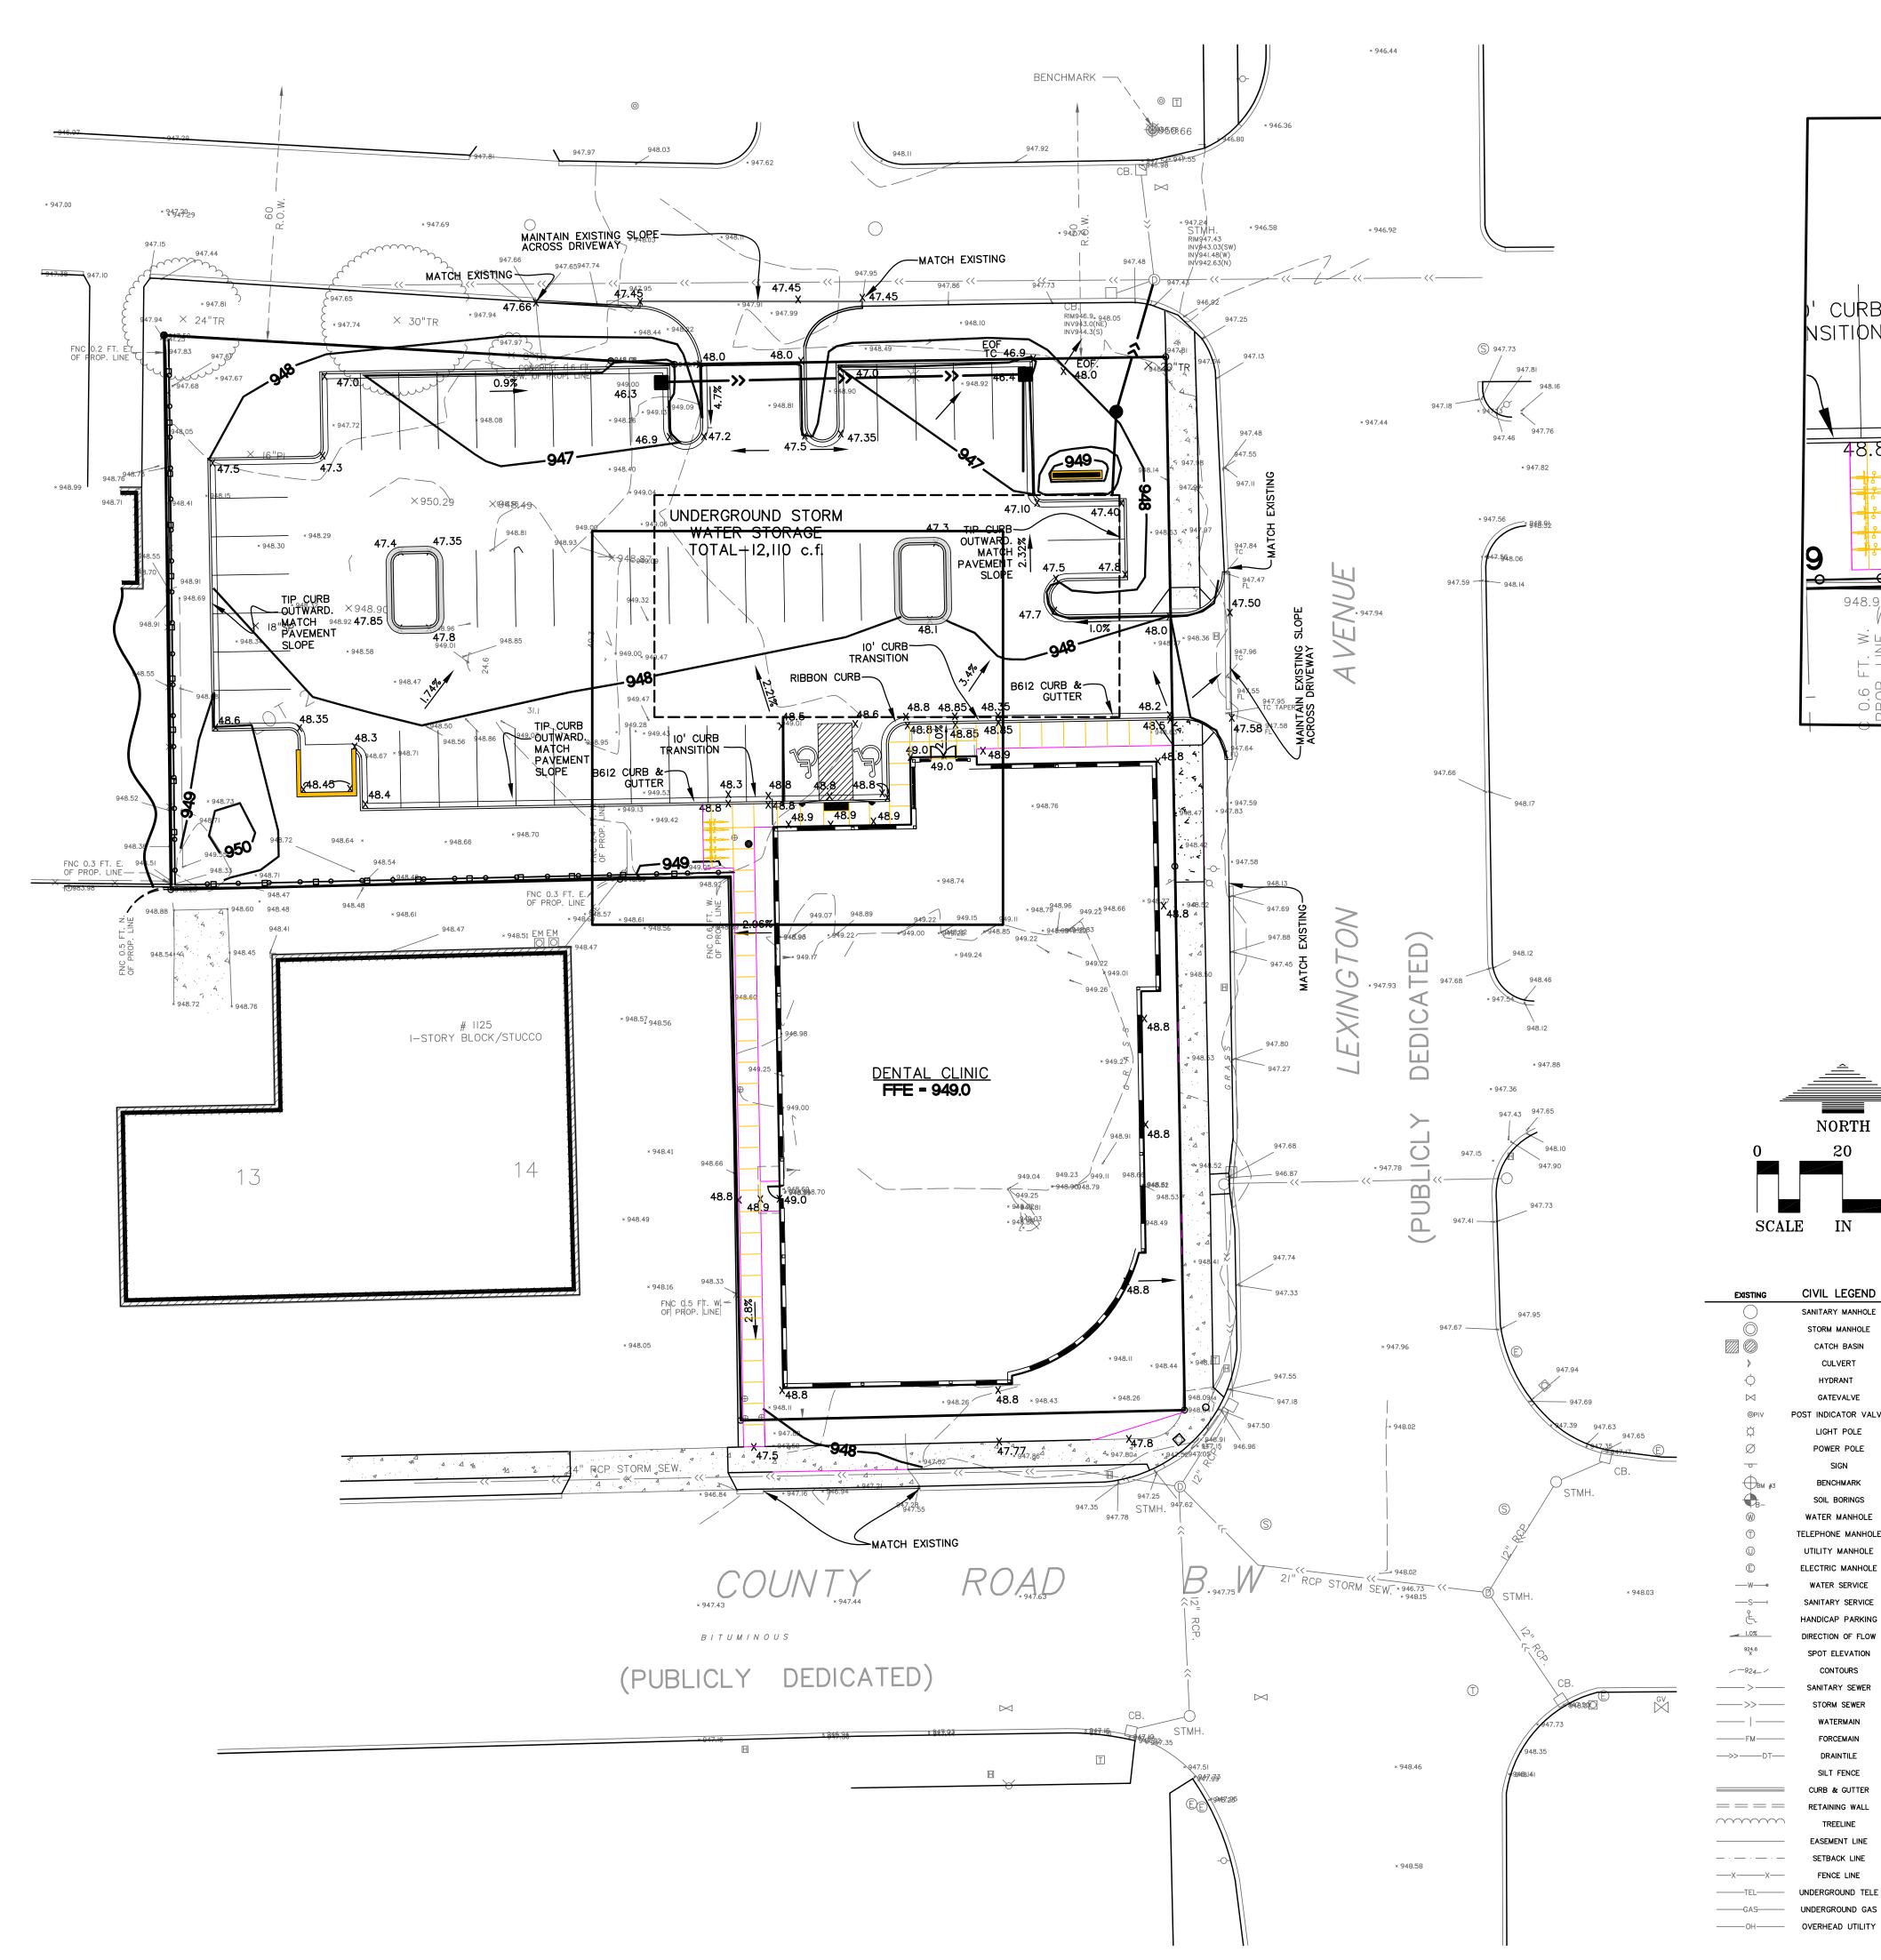

CIVIL LEGEND
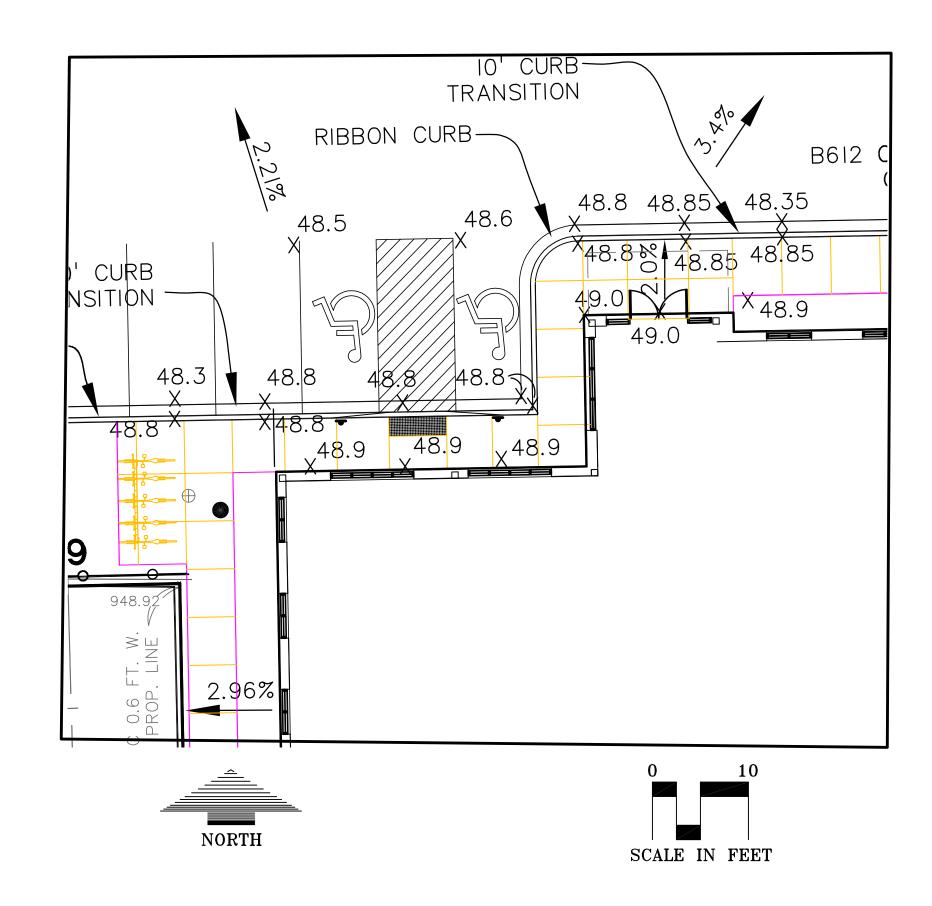
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#### GRADING, DRAINAGE & EROSION CONTROL NOTES

- I. The contractor shall refer to the architectural plans for exact locations and dimensions of buildings, vestibules, sloped paving, exit porches, ramps, truck docks, entry locations and locations of downspouts.
- 2. All disturbed unpaved areas are to receive minimum of 4 inches of top soil and sod or seed. These areas shall be watered by the contractor until the sod or seed is growing in a healthy manner.
- 3. The contractor shall take all precautions necessary to avoid property damage to adjacent properties during the construction phase of this project. The contractor will be held responsible for any damages to adjacent properties occurring during the construction phase of this project.
- 4. The contractor will be responsible for providing and maintaining traffic control devices such as barricades, warning signs, directional signs, flagmen and lights to control the movement of traffic where necessary. Placement of these devices shall be approved by the engineer prior to placement. Traffic control devices shall conform to the appropriate Minnesota department of Transportation standards.
- 5. In accordance with generally accepted construction practices, the contractor will be solely and completely responsible for conditions on the job site, including safety of all persons and property during the performance of the work. This requirement will apply continuously and not be limited to normal working hours.
- 6. The duty of the engineer or the developer to conduct construction review of the contractors performance is not intended to include review of the adequacy of the contractors safety measures in, or near the construction site.
- 7. Before beginning construction the contractor shall install a Temporary Rock Entrance pad at all points of vehicle exit from the project site. Said Rock Entrance pad shall be maintained by the contractor for the duration of the project. See details shown on Sheet C3—2 of the project plans.
- 8. Erosion and Sedimentation control measures shall be established around the entire site perimeter and in accordance with NPDES permit requirements, Best Management Practices, City requirements and the details shown on Sheet C3-2 of the project plans.
- 9. All entrances and connections to city streets shall be performed per the requirements of the city. The contractor shall be responsible for all permits and notifications as required by the city.
- 10. See utility plan and storm sewer profiles for further detail regarding the storm sewer.



Gopher State One Call

TWIN CITY AREA: 651-454-0002 TOLL FREE: I-800-252-1166

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Roseville, Minnesota

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C08261-3-1.DWG/Layout1

02-06-09	City Submittal
02-25-09	Rev. City Submittal
03-16-09	Revised City Submittal
04-29-09	Revised Building & Layout

Professional Signature:

I hereby certify that this plan, specification or report was prepared by me or under my direct supervision and that I am a duly Licensed Professional Engineer under the laws of the State of Minnesota.

	Eric Beaziey - PE	
43912		
License No.		D

Existing Conditions Plan Demolition Plan Grading and Drainage Plan


Storm Water Pollution Prevention Plan C4-1 Utility Plan C8-1, C8-2 Utility Details L1-1 Landscape Plan

Sheet Title:

Grading & Drainage Plan

08-261



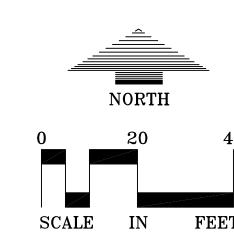

EXISTING	CIVIL LEGEND	PROPOSED
	SANITARY MANHOLE	0
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——TEL——	UNDERGROUND TELE	
——GAS——	UNDERGROUND GAS	
OH	OVERHEAD UTILITY	

#### UTILITY PLAN GENERAL NOTES

- I. All sanitary sewer, storm sewer and watermain utilities shall be furnished and installed per the requirements of the specifications, the City and the standard utilities specification of the City Engineers Association of Minnesota (CEAM), 1999 edition. All HDPE connections to concrete manholes shall be connected with an internal rubber gasket or by using ADS waterstop gasket. All sanitary sewer main line shall be SDR 35. All sanitary sewer services shall be SDR 26.
- See Sheet C8-I and the contract specifications for specific utility details and utility service details.
- 3. All utility pipe bedding shall be compacted sand or fine granular material per the requirements of the City. All compaction shall be performed per the requirements of the CEAM Specification.
- 4. All connections to existing utilities shall be performed per the requirements of the City. The City Department of Engineering and Building Inspections Department and the construction engineer must be notified at least 48 hours prior to any work within the public right of way, or work impacting public utilities.
- 5. All sanitary sewer and water services shall terminate at the property line unless
- 6. The contractor shall notify GOPHER STATE ONE CALL at 651—454—0002 at least 48 hours prior to performing any excavation or underground work.
- 7. The contractor shall field adjust watermain to avoid conflicts with sanitary sewer, storm sewer, and services as required. Insulation of water and sanitary sewer lines shall be provided where 7.5 feet minimum depth can not be attained.
- 8. All street repairs and patching shall be performed per the requirements of the City. All traffic control shall be provided by the contractor and shall be established per the requirements of the Minnesota Manual of Uniform Traffic Control Devices (MUTCD) and the City. This shall include all signage, barricades, flashers and flaggers as needed. All public streets shall be open to traffic at all times. No road closures shall be permitted without the expressed authority of of the City.
- 9. All new watermain must have a minimum of 7.5 feet of cover.
- 10. Adjust all existing structures, both public and private to the proposed grades where disturbed and comply with all requirements of the utility owners. Structures being reset to paved areas must meet owners requirements for traffic loading.
- II. Proposed Pipe Materials:

 o materials.		
Watermain	DIP Class 52	No less than 7.5' deep.
Water Service	COPPER TYPE K,I"	Service to property line.
Sanitary Sewer	PVC SDR 35	No more than 20' deep.
Sanitary Sewer	PVC SDR26	20' - 25' deep.
Sanitary Sewer	PVC 4"	Service to property line.
Storm Sewer	RCP CLASS 5	12" to 18" diameter.
Draintile	POLYETHYLENE	Back of curb.



## Gopher State One Call

TWIN CITY AREA: 651-454-0002 TOLL FREE: 1-800-252-1166

#### WARNING:

THE CONTRACTOR SHALL BE RESPONSIBLE FOR CALLING FOR LOCATIONS OF ALL EXISTING UTILITIES. THEY SHALL COOPERATE WITH ALL UTILITY COMPANIES IN MAINTAINING THEIR SERVICE AND / OR RELOCATION OF LINES.

THE CONTRACTOR SHALL CONTACT GOPHER STATE ONE CALL AT 651-454-0002 AT LEAST 48 HOURS IN ADVANCE FOR THE LOCATIONS OF ALL UNDERGROUND WIRES, CABLES, CONDUITS, PIPES, MANHOLES, VALVES OR OTHER BURIED STRUCTURES BEFORE DIGGING. THE CONTRACTOR SHALL REPAIR OR REPLACE THE ABOVE WHEN DAMAGED DURING CONSTRUCTION AT NO COST TO THE OWNER.


Project Name:

Roseville Crossing

Roseville, Minnesota

Roseville Crossing LLC.
C/O Wellington Management, Inc.

1625 Energy Park Drive, Suite 100
St.Paul, Minnesota 55108
Ph.651-292-9844 Fax.651-292-0072

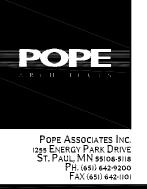

ofessional Service

## ASSOCIATES

Planning • Civil Engineering • Land Surveying Landscape Architecture • Environmental

7200 Hemlock Lane - Suite 300 Minneapolis, Minnesota 55369 Telephone: (763)424-5505 Fax: (763)424-5822 www.LoucksAssociates.com

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C08261-4-1.DWG/Layout1

#### Submittal:

06-09	City Submittal
25-09	Rev. City Submittal
16-09	Revised City Submittal
29-09	Revised Building & Layout

Professional Signature:

I hereby certify that this plan, specification or report was prepared by me or under my direct supervision and that I am a duly Licensed Professional Engineer under the laws of the State of Minnesota.

	Eric Beazley - PE
43912	
License No.	

EWB Drawn By:

EWB/RLL 2/6/0

Checked By: Review Date:

Sheet Index:

C0-1 Cover Sheet

C1-1 Existing Conditions Plan

C1-2 Demolition Plan

C2-1 Site Plan
C3-1 Grading and Drainage Plan
C3-2 Storm Water Pollution Prevention Plan
C4-1 Utility Plan

C4-1 Utility Plan
C8-1, C8-2 Utility Details
L1-1 Landscape Plan

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Sheet Title:


Utility Plan

Project No.:

08-261

OWNER.



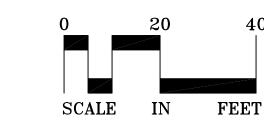

ΓING	CIVIL LEGEND	PROPOSED
	SANITARY MANHOLE	
	STORM MANHOLE	
	CATCH BASIN	Ø Z
	CULVERT	
	HYDRANT	<b>→</b>
	GATEVALVE	M
	POST INDICATOR VALVE	@PIV
	LIGHT POLE	*
	POWER POLE	ø
	SIGN	0
3	BENCHMARK	
	SOIL BORINGS	€8-
	WATER MANHOLE	
	TELEPHONE MANHOLE	
	UTILITY MANHOLE	
	ELECTRIC MANHOLE	
	WATER SERVICE	
	SANITARY SERVICE	

STORM WATER POLLUTION PREVENTION PLAN (SWPPP)

GENERAL NOTES:

I. THE NATURE OF THIS PROJECT WILL CONSIST OF CONSTRUCTING: A II,200 SQ.FT. DENTAL CLINIC, UTILITIES, AND A UNDERGROUND STORMWATER TREATMENT SYSTEM.

2. THE INTENDED SEQUENCING OF MAJOR CONSTRUCTION ACTIVITIES ARE AS FOLLOWS:

I. INSTALL STABILIZED ROCK CONSTRUCTION ENTRANCE PAD.

2. INSTALLATION OF STAGE I SILT FENCE AROUND SITE. 3. CLEAR AND GRUB FOR UNDERGROUND STORAGE SYSTEM.

4. INSTALL STAGE 2 SILT FENCE AROUND ALL STRUCTURES, PONDS AND WETLAND RESTORATION 5. CONSTRUCT UNDERGROUND STORAGE SYSTEM.

6. CLEAR AND GRUB REMAINDER OF SITE. 7. STRIP AND STOCKPILE TOPSOIL.

8. ROUGH GRADING OF SITE. 9. STABILIZE DENUDED AREAS AND STOCKPILES

10. INSTALL SANITARY SEWER, WATERMAIN, STORM SEWER, AND SERVICES. II. SUB-CUT PARKING, INSTALL PAVEMENT SECTION.

12. INSTALL CURB AND GUTTER. I3. PAVE SITE

14. INSTALL SEED AND MULCH.

15. REMOVE ACCUMULATED SEDIMENT FROM STORAGE SYSTEM. 16. WHEN ALL CONSTRUCTION ACTIVITY IS COMPLETE AND THE SITE IS STABILIZED, REMOVE SILT FENCE

AND RESEED ANY AREAS DISTURBED BY THE REMOVAL.

3. SITE DATA: AREA TO BE DISTURBED = 0.97 ac. PRIOR TO CONSTRUCTION IMPERVIOUS AREA 0.64 ac.

SOIL TYPES: SEE SOILS REPORT

POST CONSTRUCTION RUNOFF COEFFICIENT CN=89

4. THE LOCATION OF AREAS NOT TO BE DISTURBED MUST BE IDENTIFIED WITH FLAGS, STAKES, SIGNS, SILT FENCE, ETC. BEFORE CONSTRUCTION BEGINS.

5. CONSTRUCTION ACTIVITY - EROSION PREVENTION PRACTICES TIME AN AREA CAN REMAIN

OPEN WHEN NOT ACTIVELY BEING WORKED: 7 DAYS 10:1 TO 3:1 I4 DAYS FLATTER THAN 10:1 21 DAYS DENOTES SLOPES STEEPER THAN 3:1

6. ON SLOPES 3:1 OR GREATER MAINTAIN SHEET FLOW AND MINIMIZE RILLS AND/OR GULLIES, SLOPE LENGTHS CAN NOT BE GREATER THAN 75 FEET.

7. ALL STORM DRAINS AND INLETS MUST BE PROTECTED UNTIL ALL SOURCES OF POTENTIAL DISCHARGE ARE STABILIZED.

8. TEMPORARY SOIL STOCKPILES MUST HAVE EFFECTIVE SEDIMENT CONTROL AND CAN NOT BE PLACED IN SURFACE WATERS OR STORM WATER CONVEYANCE SYSTEMS. TEMPORARY STOCKPILES WITHOUT SIGNIFICANT AMOUNT OF SILT, CLAY, OR ORGANIC COMPOUNDS ARE EXEPMT {EX: CLEAN AGGREGATE STOCK PILES, DEMOLITION CONCRETE STOCKPILES, SAND STOCKPILES}.

9. SEDIMENT LADEN WATER MUST BE DISCHARGED TO A SEDIMENTATION BASIN WHENEVER POSSIBLE. IF NOT POSSIBLE, IT MUST BE TREATED WITH THE APPROPRIATE BMP'S.

IO. SOLID WASTE MUST BE DISPOSED OF PROPERLY AND MUST COMPLY WITH MPCA DISPOSAL REQUIREMENTS.

II. EXTERNAL WASHING OF CONSTRUCTION VEHICLES MUST BE LIMITED TO A DEFINED AREA OF THE SITE.

12. NO ENGINE DEGREASING IS ALLOWED ON SITE.

13. THE OWNER WHO SIGNS THE NPDES PERMIT APPLICATION IS A PERMITTEE AND IS RESPONSIBLE FOR COMPLIANCE WITH ALL TERMS AND CONDITIONS OF THE PERMIT. THE OPERATOR (CONTRACTOR) WHO SIGNS THE NPDES PERMIT APPLICATION IS A PERMITTEE FOR PARTS II.B., PART II.C AND PART IV. OF THE NPDES PERMIT AND IS JOINTLY RESPONSIBLE WITH THE OWNER FOR COMPLIANCE WITH THOSE PORTIONS OF THE PERMIT.

14. CHANGE OF COVERAGE-UPON COMPLETION OF GRADING, UTILITIES, AND STREET CONSTRUCTION THE NEW OWNER (HOME BUILDER) MUST SUBMIT A SUBDIVISION REGISTRATION WITHIN 7 DAYS OF ASSUMING OPERATIONAL CONTROL OF THE SITE, COMMENCING WORK ON THEIR PORTION OF THE SITE, OR OF THE LEGAL TRANSFER, SALE OR CLOSING ON THE PROPERTY. NOTE: THE NEW CAN IMPLEMENT THE ORIGINAL SWPPP CREATED FOR THE PROJECT OR DEVELOP AND IMPLEMENT THEIR OWN SWPPP.

15. TERMINATION OF COVERAGE—PERMITTEE(S) WISHING TO TERMINATE COVERAGE MUST SUBMIT A NOTICE OF TERMINATION (NOT) TO THE MPCA. ALL PERMITTEE(S) MUST SUBMIT A NOT WITHIN 30 DAYS AFTER ONE OR MORE OF THE FOLLOWING CONDITIONS HAVE BEEN MET: A. FINAL STABILIZATION, PER NPDES PERMIT PART IV.G. AND DEFINITION IN APPENDIX B HAS BEEN ACHIEVED ON ALL PORTIONS OF THE SITE FOR WHICH THE PERMITTEE IS RESPONSIBLE. B. ANOTHER OWNER HAS ASSUMED CONTROL OVER ALL AREAS OF THE SITE THAT HAVE NOT BEEN FINALLY STABILIZED. C. FOR RESIDENTIAL CONSTRUCTION ONLY, TEMPORARY EROSION PROTECTION AND DOWN GRADIENT PERIMETER CONTROL FOR INDIVIDUAL LOTS HAS BEEN COMPLETED AND THE RESIDENCE HAS BEEN TRANSFERRED TO THE HOMEOWNER. ADDITIONALLY, THE PERMITTEE MUST DISTRIBUTE THE MPCA'S

BENEFITS OF, FINAL STABILIZATION.

A. INITIAL INSPECTION FOLLOWING SILT FENCE INSTALLATION BY CITY REPRESENTATIVE IS REQUIRED. B. EXPOSED SOIL AREAS: ONCE EVERY 7 DAYS AND WITHIN 24 HOURS FOLLOWING A 0.5" OVER 24 HOURS RAIN EVENT. C. STABILIZED AREAS: ONCE EVERY 30 DAYS

"HOMEOWNER FACTSHEET" TO THE HOMEOWNER TO INFORM THE HOMEOWNER OF THE NEED FOR, AND

D. FROZEN GROUND: AS SOON AS RUNOFF OCCURS OR PRIOR TO RESUMING CONSTRUCTION.

17. OWNER MUST KEEP RECORDS OF ALL PERMITS REQUIRED FOR THE PROJECT, ALL INSPECTIONS AND MAINTENANCE, PERMANENT OPERATION AND MAINTENANCE AGREEMENTS, AND REQUIRED CALCULATIONS FOR TEMPORARY AND PERMANENT STORM WATER MANAGEMENT SYSTEMS. THESE RECORDS MUST BE RETAINED FOR THREE YEARS.

18. SWPPP MUST BE AMENDED WHEN:

A. THERE IS A CHANGE IN DESIGN, OPERATION, MAINTENANCE, WEATHER OR SEASONAL CONDITIONS THAT HAS A SIGNIFICANT EFFECT ON DISCHARGE B. INSPECTIONS INDICATE THAT THE SWPPP IS NOT EFFECTIVE AND DISCHARGE IS EXCEEDING WATER QUALITY STANDARDS.

C. THE BMP'S IN THE SWPPP ARE NOT CONTROLLING POLLUTANTS IN DISCHARGES OR IS NOT CONSISTENT WITH THE TERMS AND CONDITIONS OF THE PERMIT.


SILT FENCE REQUIRED MAINTENANCE:

WHEN SEDIMENT REACHES I/3 THE HEIGHT OF SILT FENCE IT MUST BE REMOVED WITHIN 24 HOURS. 2. REPAIR OR REPLACE DISFUNCTIONAL SILT FENCE WITHIN 24 HOURS.

Roseville Crossing

Roseville, Minnesota

Roseville Crossing LLC. C/O Wellington Management, Inc. 1625 Energy Park Drive, Suite 100 St.Paul, Minnesota 55108 Ph.651-292-9844 Fax.651-292-0072

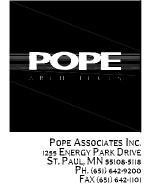

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C08261-3-2.DWG/Layout1

Revised City Submittal 04-29-09 Revised Building & Layout

Professional Signature I hereby certify that this plan, specification or report was

prepared by me or under my direct supervision and that I am a duly Licensed Professional Engineer under the laws

of the State of Minnesota.

Eric Beazlev - PE

License No.

Existing Conditions Plan

Demolition Plan Site Plan Grading and Drainage Plan Storm Water Pollution Prevention Plan

C4-1 Utility Plan C8-1, C8-2 Utility Details

L1-1 Landscape Plan

Sheet Title:

Storm Water Pollution Prevention Plan

08-261

NO PLANTING WILL BE INSTALLED UNTIL COMPLETE GRADING AND CONSTRUCTION HAS BEEN COMPLETED IN THE IMMEDIATE AREA.

WHERE SOD/SEED ABUTS PAVED SURFACES, FINISHED GRADE OF SOD/SEED SHALL BE HELD 1" BELOW SURFACE ELEVATION OF TRAIL. SLAB, CURB, ETC.

SEED ALL AREAS DISTURBED DUE TO GRADING OTHER THAN THOSE AREAS NOTED TO RECEIVE SOD. SEED SHALL BE INSTALLED AND MULCHED AS PER MNDOT SPECS.

SOD ALL DESIGNATED AREAS DISTURBED DUE TO GRADING. SOD SHALL BE LAID PARALLEL TO THE CONTOURS AND SHALL HAVE STAGGERED JOINTS. ON SLOPES STEEPER THAN 3:1 OR IN DRAINAGE SWALES, THE SOD SHALL BE STAKED TO THE GROUND.

ALL PLANT MATERIAL SHALL COMPLY WITH THE LATEST EDITION OF THE AMERICAN STANDARD FOR NURSERY STOCK, AMERICAN ASSOCIATION OF NURSERYMEN. UNLESS NOTED OTHERWISE DECIDUOUS SHRUBS SHALL HAVE AT LEAST 5 CANES AT THE SPECIFIED SHRUB HEIGHT. ORNAMENTAL TREES SHALL HAVE NO V CROTCHES AND SHALL BEGIN BRANCHING NO LOWER THAN 3' ABOVE ROOT BALL. STREET AND BOULEVARD TREES SHALL BEGIN BRANCHING NO LOWER THAN 6' ABOVE FINISHED GRADE.

ANY CONIFEROUS TREE PREVIOUSLY PRUNED FOR CHRISTMAS TREE SALES SHALL NOT BE USED. ALL CONIFEROUS TREES SHALL BE FULL FORM, NATURAL TO THE SPECIES, WITHOUT PRUNING.

PLAN TAKES PRECEDENCE OVER PLANT SCHEDULE IF DISCREPANCIES IN QUANTITIES EXIST. SPECIFICATIONS TAKE PRECEDENCE OVER

ALL PROPOSED PLANTS SHALL BE LOCATED AND STAKED AS SHOWN ON PLAN. LANDSCAPE ARCHITECT MUST APPROVE ALL STAKING OF PLANT MATERIAL PRIOR TO ANY AND ALL DIGGING.

NO PLANT MATERIAL SUBSTITUTIONS WILL BE ACCEPTED UNLESS APPROVAL IS REQUESTED OF THE LANDSCAPE ARCHITECT BY THE LANDSCAPE CONTRACTOR PRIOR TO THE SUBMISSION OF A BID AND/OR QUOTATION.

ADJUSTMENTS IN LOCATION OF PROPOSED PLANT MATERIALS MAY BE NEEDED IN FIELD. SHOULD AN ADJUSTMENT BE ADVISED, THE LANDSCAPE ARCHITECT MUST BE NOTIFIED.

ALL PLANT MATERIALS SHALL BE FERTILIZED UPON INSTALLATION WITH DRIED BONE MEAL, OTHER APPROVED FERTILIZER MIXED IN WITH THE PLANTING SOIL PER THE MANUFACTURER'S INSTRUCTIONS OR MAY BE TREATED FOR SUMMER AND FALL INSTALLATION WITH AN APPLICATION OF GRANULAR 0-20-20 OF 12 OZ PER 2.5" CALIPER PER TREE AND 6 OZ PER SHRUB WITH AN ADDITIONAL APPLICATION OF 10-10-10 THE FOLLOWING SPRING IN THE TREE SAUCER.

ALL PLANTING AREAS RECEIVING GROUND COVER, PERENNIALS, ANNUALS, AND/OR VINES SHALL RECEIVE A MINIMUM OF 8" DEPTH OF PLANTING SOIL CONSISTING OF AT LEAST 45 PARTS TOPSOIL, 45 PARTS PEAT OR MANURE AND 10 PARTS SAND.

ALL PLANTS TO BE INSTALLED AS PER PLANTING DETAILS.

WRAPPING MATERIAL SHALL BE CORRUGATED PVC PIPING 1" GREATER IN CALIPER THAN THE TREE BEING PROTECTED OR QUALITY, HEAVY, WATERPROOF CREPE PAPER MANUFACTURED FOR THIS PURPOSE. WRAP ALL DECIDUOUS TREES PLANTED IN THE FALL PRIOR TO 12-1 AND REMOVE ALL WRAPPING AFTER 5-1.

BLACK POLY EDGER TO BE USED TO CONTAIN SHRUBS, PERENNIALS, AND ANNUALS WHERE BED MEETS SOD/SEED UNLESS NOTED OTHERWISE.

I SHRUB BED MASSINGS TO RECEIVE 3" DEEP SHREDDED HARDWOOD MULCH AND FIBER MAT WEED BARRIER.

ALL TREES TO RECEIVE 4" DEEP SHREDDED HARDWOOD MULCH WITH NO MULCH IN DIRECT CONTACT WITH TREE TRUNK.

ALL ANNUAL AND PERENNIAL PLANTING BEDS TO RECEIVE 3" DEEP SHREDDED HARDWOOD MULCH WITH NO WEED BARRIER.

SPREAD GRANULAR PRE EMERGENT HERBICIDE (PREEN OR EQUAL) PER MANUFACTURES RECOMMENDATIONS UNDER ALL MULCHED AREAS.

MAINTENANCE STRIPS TO HAVE EDGER AND MULCH AS SPECIFIED/INDICATED ON DRAWING OR IN SPECIFICATION.

VERIFY EXISTING/PROPOSED IRRIGATION SYSTEM LAYOUT AND CONFIRM COMPLETE LIMITS OF IRRIGATION PRIOR TO SUPPLYING SHOP DRAWINGS.

LANDSCAPE CONTRACTOR SHALL BE RESPONSIBLE FOR PROVIDING AN IRRIGATION LAYOUT PLAN AND SPECIFICATION AS A PART OF THE SCOPE OF WORK WHEN BIDDING. THESE SHALL BE APPROVED BY THE LANDSCAPE ARCHITECT PRIOR TO ORDER AND/OR INSTALLATION. IT SHALL BE THE LANDSCAPE CONTRACTORS RESPONSIBILITY TO INSURE THAT ALL SODDED/SEEDED AND PLANTED AREAS ARE IRRIGATED PROPERLY, INCLUDING THOSE AREAS DIRECTLY AROUND AND ABUTTING BUILDING FOUNDATION.

THE LANDSCAPE CONTRACTOR SHALL PROVIDE THE OWNER WITH A WATERING/LAWN IRRIGATION SCHEDULE APPROPRIATE TO THE PROJECT SITE CONDITIONS AND TO PLANT MATERIAL GROWTH REQUIREMENTS.

IF THE LANDSCAPE CONTRACTOR IS CONCERNED OR PERCEIVES ANY DEFICIENCIES IN THE PLANT SELECTIONS, SOIL CONDITIONS OR ANY OTHER SITE CONDITION WHICH MIGHT NEGATIVELY AFFECT PLANT ESTABLISHMENT, SURVIVAL OR GUARANTEE, HE MUST BRING THESE DEFICIENCIES TO THE ATTENTION OF THE LANDSCAPE ARCHITECT PRIOR TO PROCUREMENT AND/OR INSTALLATION.

CONTRACTOR SHALL SUBMIT A WRITTEN REQUEST FOR THE OWNER ACCEPTANCE INSPECTION OF ALL LANDSCAPE AND SITE IMPROVEMENTS.

CONTRACTOR IS RESPONSIBLE FOR ON-GOING MAINTENANCE OF ALL NEWLY INSTALLED MATERIALS UNTIL TIME OF OWNER ACCEPTANCE. ANY ACTS OF VANDALISM OR DAMAGE WHICH MAY OCCUR PRIOR TO OWNER ACCEPTANCE SHALL BE THE RESPONSIBILITY OF THE CONTRACTOR. CONTRACTOR SHALL PROVIDE THE OWNER WITH A MAINTENANCE PROGRAM INCLUDING, BUT NOT NECESSARILY LIMITED

CONTRACTOR SHALL GUARANTEE NEW PLANT MATERIAL THROUGH ONE

WARRANTY (ONE FULL GROWING SEASON) FOR LANDSCAPE MATERIALS SHALL BEGIN ON THE DATE OF ACCEPTANCE BY THE LANDSCAPE ARCHITECT AFTER THE COMPLETION OF PLANTING OF ALL LANDSCAPE

REPRODUCIBLE AS-BUILT DRAWING(S) OF ALL LANDSCAPE CONSTRUCTION INSTALLATION AND PRIOR TO PROJECT ACCEPTANCE.

UNLESS NOTED OTHERWISE THE APPROPRIATE DATES FOR SPRING PLANT MATERIAL INSTALLATION AND SEED/SOD PLACEMENT IS FROM THE TIME GROUND HAS THAWED TO JUNE 15.

FALL SODDING IS GENERALLY ACCEPTABLE FROM AUGUST 15 -NOVEMBER 1. FALL SEEDING FROM AUGUST 15 - SEPTEMBER 15; DORMANT SEEDING IN THE FALL SHALL NOT OCCUR PRIOR TO NOVEMBER 1. PLANTING OUTSIDE THESE DATES IS NOT RECOMMENDED. ANY ADJUSTMENT MUST BE APPROVED IN WRITING BY THE LANDSCAPE ARCHITECT.

CONIFEROUS PLANTING MAY OCCUR FROM AUGUST 15 - OCTOBER 1 AND FALL DECIDUOUS PLANTING FROM THE FIRST FROST UNTIL NOVEMBER 15. PLANTING OUTSIDE THESE DATES IS NOT RECOMMENDED. ANY ADJUSTMENT MUST BE APPROVED IN WRITING BY THE LANDSCAPE ARCHITECT.

PROTECT ALL EXISTING OAKS ON SITE SCHEDULED TO REMAIN. IF EXISTING OAKS ARE DAMAGED IN ANY MANNER, ABOVE OR BELOW GROUND IN THE ROOT SYSTEM, AN ASPHALTIC TREE PRUNING PAINT SHOULD BE APPLIED IMMEDIATELY AFTER WOUNDING. OAKS ARE NOT TO BE PRUNED, REMOVED OR TRANSPLANTED BETWEEN APRIL 15 AND JULY 1. NOTIFY LANDSCAPE ARCHITECT IF THESE DATES ARE UNAVOIDABLE.

LANDSCAPE CONTRACTOR SHALL ESTABLISH TO HIS SATISFACTION THAT SOIL AND COMPACTION CONDITIONS ARE ADEOUATE TO ALLOW FOR PROPER DRAINAGE AT AND AROUND THE BUILDING SITE.

> LANDSCAPE REQUIREMENTS: 1 TREE PER 50 FEET OF PARKING LOT FRONTAGE. TREES REQUIRED = 71 TREE PER 25 PARKING SPACES

TREES REQUIRED = 2**TOTAL TREES REQUIRED = 9** (25% MUST BE CONIFEROUS) TREES PROVIDED = 6

**EXISTING TREES TO REMAIN = 3** 

LANDSCAPE DETAILS:

REFER TO PLAN

18" MIN.

GENERAL NOTES

CONTRACTOR SHALL VISIT SITE PRIOR TO SUBMITTING BID. HE SHALL INSPECT SITE AND BECOME FAMILIAR WITH EXISTING CONDITIONS RELATING TO THE NATURE AND SCOPE OF WORK.

VERIFY LAYOUT AND ANY DIMENSIONS SHOWN AND BRING TO THE ATTENTION OF THE LANDSCAPE ARCHITECT ANY DISCREPANCIES WHICH MAY COMPROMISE THE DESIGN AND/OR INTENT OF THE PROJECT'S LAYOUT.

ASSURE COMPLIANCE WITH ALL APPLICABLE CODES AND REGULATIONS GOVERNING THE WORK OR MATERIALS SUPPLIED.

CONTRACTOR SHALL PROTECT ALL EXISTING ROADS, CURBS/GUTTERS, TRAILS, TREES, LAWNS AND SITE ELEMENTS DURING PLANTING OPERATIONS. ANY DAMAGE TO SAME SHALL BE REPAIRED AT NO COST TO THE OWNER.

CONTRACTOR SHALL VERIFY ALIGNMENT AND LOCATION OF ALL UNDERGROUND AND ABOVE GRADE UTILITIES AND PROVIDE THE NECESSARY PROTECTION FOR SAME BEFORE CONSTRUCTION / MATERIAL

ALL UNDERGROUND UTILITIES SHALL BE LAID SO THAT TRENCHES DO NOT CUT THROUGH ROOT SYSTEMS OF ANY EXISTING TREES TO

INSTALLATION BEGINS (MINIMUM 10' - 0" CLEARANCE).

EXISTING CONTOURS, TRAILS, VEGETATION, CURB/GUTTER AND OTHER EXISTING ELEMENTS BASED UPON INFORMATION SUPPLIED TO LANDSCAPE ARCHITECT BY OTHERS. CONTRACTOR SHALL VERIFY ANY AND ALL DISCREPANCIES PRIOR TO CONSTRUCTION AND NOTIFY LANDSCAPE ARCHITECT OF SAME.

THE ALIGNMENT AND GRADES OF THE PROPOSED WALKS, TRAILS AND/OR ROADWAYS ARE SUBJECT TO FIELD ADJUSTMENT REQUIRED TO CONFORM TO LOCALIZED TOPOGRAPHIC CONDITIONS AND TO MINIMIZE TREE REMOVAL AND GRADING. ANY CHANGE IN ALIGNMENT MUST BE APPROVED BY LANDSCAPE ARCHITECT.

— SHREDDED HARDWOOD MULCH IN ALL PLANTING BEDS THE CONTRACTOR IS RESPONSIBLE FOR MAINTAINING ALL TREES IN A PLUMB POSITION THROUGH THE WARRANTY PERIOD. STAKING IS SUGGESTED, BUT NOT REQUIRED. ANY STAKING MUST CONFORM WITH PRACTICES AS DEFINED IN A.N.A. GUIDELINES FOR STANDARD PRACTICES

LANDSCAPE PLAN:

-EXISTING TREES-

TO REMAIN

**WOOD FENCE** 

SANDHURST

SOD ALL DISTURBED AREAS

DENTAL CLINIC

SCIENTIFIC NAME

Quercus bicolor

Malus x 'Pink Spires

Pinus nigra

Tilia americana "McSentry"

Spirea x bumalda 'Anthony Waterer'

Juniperus horizontalis 'Mother Lode'

Diervilla sessilifolia 'Butterfly'

Picea abies 'Elegans'

Taxus x media 'Taunton'

Rudbeckia fulgida 'Goldsturm'

Hemerocallis x 'Daring Deception'

Echinacea purpurea 'Little Magnus'

Calamagrostis acutiflora 'Karl Foerster'

PROTECT EXISTING

-WOOD-FENCE

SYM QTY COMMON NAME

BO 2 BICOLOR OAK

SL 2 SENTRY LINDEN

AP 2 AUSTRIAN PINE

BB 40 BUTTERFLYBUSH

ES 32 ELEGANS SPRUCE

TY 15 TAUNTON YEW

ML 16 MOTHER LODE JUNIPER

BS 40 BLACK EYED SUSAN

PS 5 PINK SPIRES CRABAPPLE

AS 34 ANTHONY WATERER SPIREA

AJ 23 ANDORRA COMPACT JUNIPER

20 KARL FOERSTER GRASS

DECIDUOUS TREES

ORNAMENTAL TREES

EVERGREEN TREES

DECIDUOUS SHRUBS

CONIFEROUS SHRUBS

PERENNIALS

PRUNE DAMAGED AND CROSSING BRANCHES AFTER PLANTING IS COMPLETE. CUT BACK WIRE BASKET REMOVE ALL FLAGGING AND LABELING WATER TREE THOROUGHLY DURING

PLANTING OPERATIONS. PLACE BACKFILL IN 8-12" LIFTS AND SATURATE SOIL WITH WATER. DO NOT COMPACT MORE THAN NECESSARY TO MAINTAIN PLUMB. - 16"x2" POLYPROPYLENE OR POLYETHYLENE STRAP TREE WRAP TO FIRST BRANCH

SAFETY FLAGGING - ONE PER WIRE ROOT FLARE EVEN WITH OR JUST ABOVE GRADE. MULCH - 4" DEEP. NO MULCH IN CONTACT WITH TRUNK - SEE SPECS. WOOD STAKE (OPTIONAL)

EDGE VARIES - SEE PLAN SCARIFY BOTTOM AND SIDES OF HOLE PRIOR TO PLANTING

SET PLANT ON UNDISTURBED NATIVE SOIL CONTRACTOR IS RESPONSIBLE FOR TESTING PERCOLATION RATES PRIOR TO PLANTING. NOTIFY LANDSCAPE ARCHITECT IMMEDIATELY IF POOR DRAINAGE EXISTS.

x ROOT BAL

DECIDUOUS TREE PLANTING DETAIL

.2 X ROOT BALL WIDTH

THE CONTRACTOR IS RESPONSIBLE FOR MAINTAINING ALL TREES IN A PLUMB POSITION THROUGH THE WARRANTY PERIOD. STAKING IS SUGGESTED, BUT NOT REQUIRED. ANY STAKING MUST CONFORM WITH PRACTICES AS DEFINED IN A.N.A. GUIDELINES FOR STANDARD PRACTICES PRUNE ANY DAMAGED BRANCHES AFTER PLANTING IS COMPLETE.

Deciduous Tree.DWG

REMOVE ALL FLAGGING AND LABELING FROM TREE WATER TREE THOROUGHLY DURING PLANTING OPERATIONS. PLACE BACKFILL IN 8-12" LIFTS AND SATURATE SOIL WITH WATER. DO NOT COMPACT MORE THAN NECESSARY TO MAINTAIN PLUMB. 16"x2" POLYPROPYLENE OR

POLYETHYLENE STRAP

ROOT BALL SET ON MOUNDED SUBGRADE CONTRACTOR IS RESPONSIBLE FOR TESTING PERCOLATION RATES PRIOR TO PLANTING. NOTIFY LANDSCAPE ARCHITECT

CONIFEROUS TREE PLANTING DETAII


DD 34 DARING DECEPTION DAYLILY LC 43 LITTLE MAGNUS CONEFLOWER Coniferous Tree.DWG

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L1-1-08261.DWG/Layout

02-06-09 City Submittal

I hereby certify that this plan, specification or report was prepared by me or under my direct supervision and that I am a duly Licensed Landscape Architect under the laws

Paul Kangas - ASLA License No.

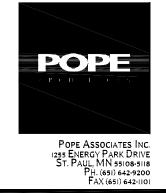SCALE

IN

SIZE CONT COMMENTS

2.5" CAL B&B SINGLE STEM

2.5" CAL B&B SINGLE STEM

1.5" CAL | B&B | SINGLE STEM

6' HGT | B&B | FULL FORM

24" HGT | POT | PLANT 5' O.C.

24" HGT | POT | PLANT 4' O.C.

36" HGT POT PLANT 5' O.C.

24" SPRD POT PLANT 6' O.C.

24" SPRD POT PLANT 5' O.C.

1 GAL POT PLANT 2' O.C.

Juniperus horizontalis 'Plumosa Compacta' 24" SPRD POT PLANT 6' O.C.

FEET

of the State of Minnesota

Ouality Contro

Sheet Index: C0-1 Cover Sheet Existing Conditions Pla Demolition Plan Site Plan

Grading and Drainage Plan Storm Water Pollution Prevention Plan C4-1 Utility Plan C8-1, C8-2 Utility Details L1-1 Landscape Plan

Sheet Title:

LANDSCAP

TO, PRUNING, FERTILIZATION AND DISEASE/PEST CONTROL. CALENDAR YEAR FROM THE DATE OF OWNER ACCEPTANCE.

MATERIALS. NO PARTIAL ACCEPTANCE WILL BE CONSIDERED.

INSTALLATION AND SITE IMPROVEMENTS UPON COMPLETION OF

 BUILDING WALL (TYP) SHRUB PLANTING DETAIL SCALE: 3/4" = 1'-0"- MULCH - SEE SPECS. 3" DEPTH — EDGER - SEE SPECS. — EDGE VARIES - SEE PLAN - 12" DEPTH (MIN). LOAM PLANTING SOIL - SEE SPECS. LOOSEN ROOTS OF PLANT MATERIAL PRIOR TO PLANTING RENNIAL PLANTING Perennial.Dwg

LOOSEN ROOTS OF ALL

CONTAINERIZED PLANTS.

WITH PROPOSED GRADE.

MULCH - 3" DEEP - SEE SPEC

— LANDSCAPE FABRIC - SEE SPEC

EDGING MATERIAL - SEE SPEC.

· EDGE VARIES - REFER TO PLAN

PLANTING SOIL - SEE SPEC.

HOLE PRIOR TO PLANTING

SCARIFY BOTTOM AND SIDES OF

SHRUBS TO BE PLACED SO THAT TOP OF CONTAINER SITS FLUSH

TREE PROTECTION NOTE: INSTALL SNOW FENCE AROUND EACH TREE TO BE PROTECTED PRIOR TO GRADING. FENCE SHALL BE PLACED AT THE DRIP EDGE OR CRITICAL ROOT ZONES OF THE TREES. FENCING SHALL BE NO CLOSER THAN 6' TO THE TRUNK OF ANY TREE TO BE PROTECTED. THE PERIMETERS FOR TREES BEING PROTECTED SHALL BE DESIGNATED AT ALL TIMES DURING CONSTRUCTION ACTIVITY AND SIGNAGE SHALL BE INSTALLED AT ALL TREE PROTECTION AREAS THAT INSTRUCTS WORKERS TO STAY OUT. CONTRACTOR SHALL AVOID ALL AREAS WITHIN TREE PROTECTION FENCE. SOIL SHOULD BE PROTECTED FROM EROSION AND CHANGES IN CHEMISTRY FROM CONCRETE OR TOXIC MATERIALS SUCH AS FUELS AND PAINTS.

THE CONTRACTOR SHALL HAVE "TREE PAINT" ON SITE AT ALL TIMES. IF AN OAK IS WOUNDED DURING CONSTRUCTION, THE CONTRACTOR MUST IMMEDIATELY APPLY PAINT TO THE WOUND IN ORDER TO PREVENT OAK WILT. ALL DAMAGE TO TREES TO BE PROTECTED SHALL BE BROUGHT TO THE

**—** EXISTING TREE TO REMAIN - DRIP EDGE OF TREE 2" X 4" WOOD STAKE, POSITIONED AS NOTED. STRING 4' HIGH, ORANGE POLYETHYLENE LAMINAR SAFETY netting between wood stakes PLACED 5' ON CENTER AND PLACED BETWEEN TREE PROTECTION AND DISTURBED AREAS. **EXISTING GRADE** TREE PROTECTION

· SAFETY FLAGGING - ONE PER WIRE - MULCH - 4" DEEP - PER SPECS. MULCH MUST NOT BE IN CONTACT WITH TRUNK. WOOD STAKE (OPTIONAL) — EDGE VARIES - SEE PLAN - SCARIFY BOTTOM AND SIDES OF HOLE PRIOR TO PLANTING


IMMEDIATELY IF POOR DRAINAGE EXISTS.


### SITE PLAN GENERAL NOTES

A) SITE INFORMATION HAS BEEN TAKEN FROM A SITE SURVEY PREPARED BY HANSEN THORP PELLINEN OLSON INC. 1510 MARKET PLACE DRIVE EDEN PRAIRIE, MN 55344-3644 DATED 1-13-09. GENERAL CONTRACTOR IS TO VERIFY ALL SITE INFORMATION BEFORE STARTING CONSTRUCTION, AND NOTIFY THE ARCHITECT IN WRITING OF ANY DISCREPANCIES.

B) REFER TO THE GENERAL NOTES FOR OTHER APPLICABLE INFORMATION.

SITE DATA		
ZONING DISTRICT: B3 & R1		
ZONING REQUIREMENTS	REQUIRED	PROVIDED
BUILDING SETBACKS FRONT REAR SIDE	30' 20' 10'	4' AND 7' NA 10'
PARKING SETBACKS FRONT REAR SIDE	15' 5' 10'	6 1/2" 17'-5" 10'
SITE AREA		42,063 S.F. (0.9656 ACRES)
PROPOSED BUILDING AREA		11,877 S.F.
FLOOR AREA RATIO	1.0 MAX	0.26
PARKING AREA		19,127 S.F.
LANDSCAPE RATIO IN PARKING AREA (5% OF PARKING AREA)	1,385 S.F.	6,583 S.F.
PARKING SPACES (based on 8,884 s.f. of tenant space)	44	48

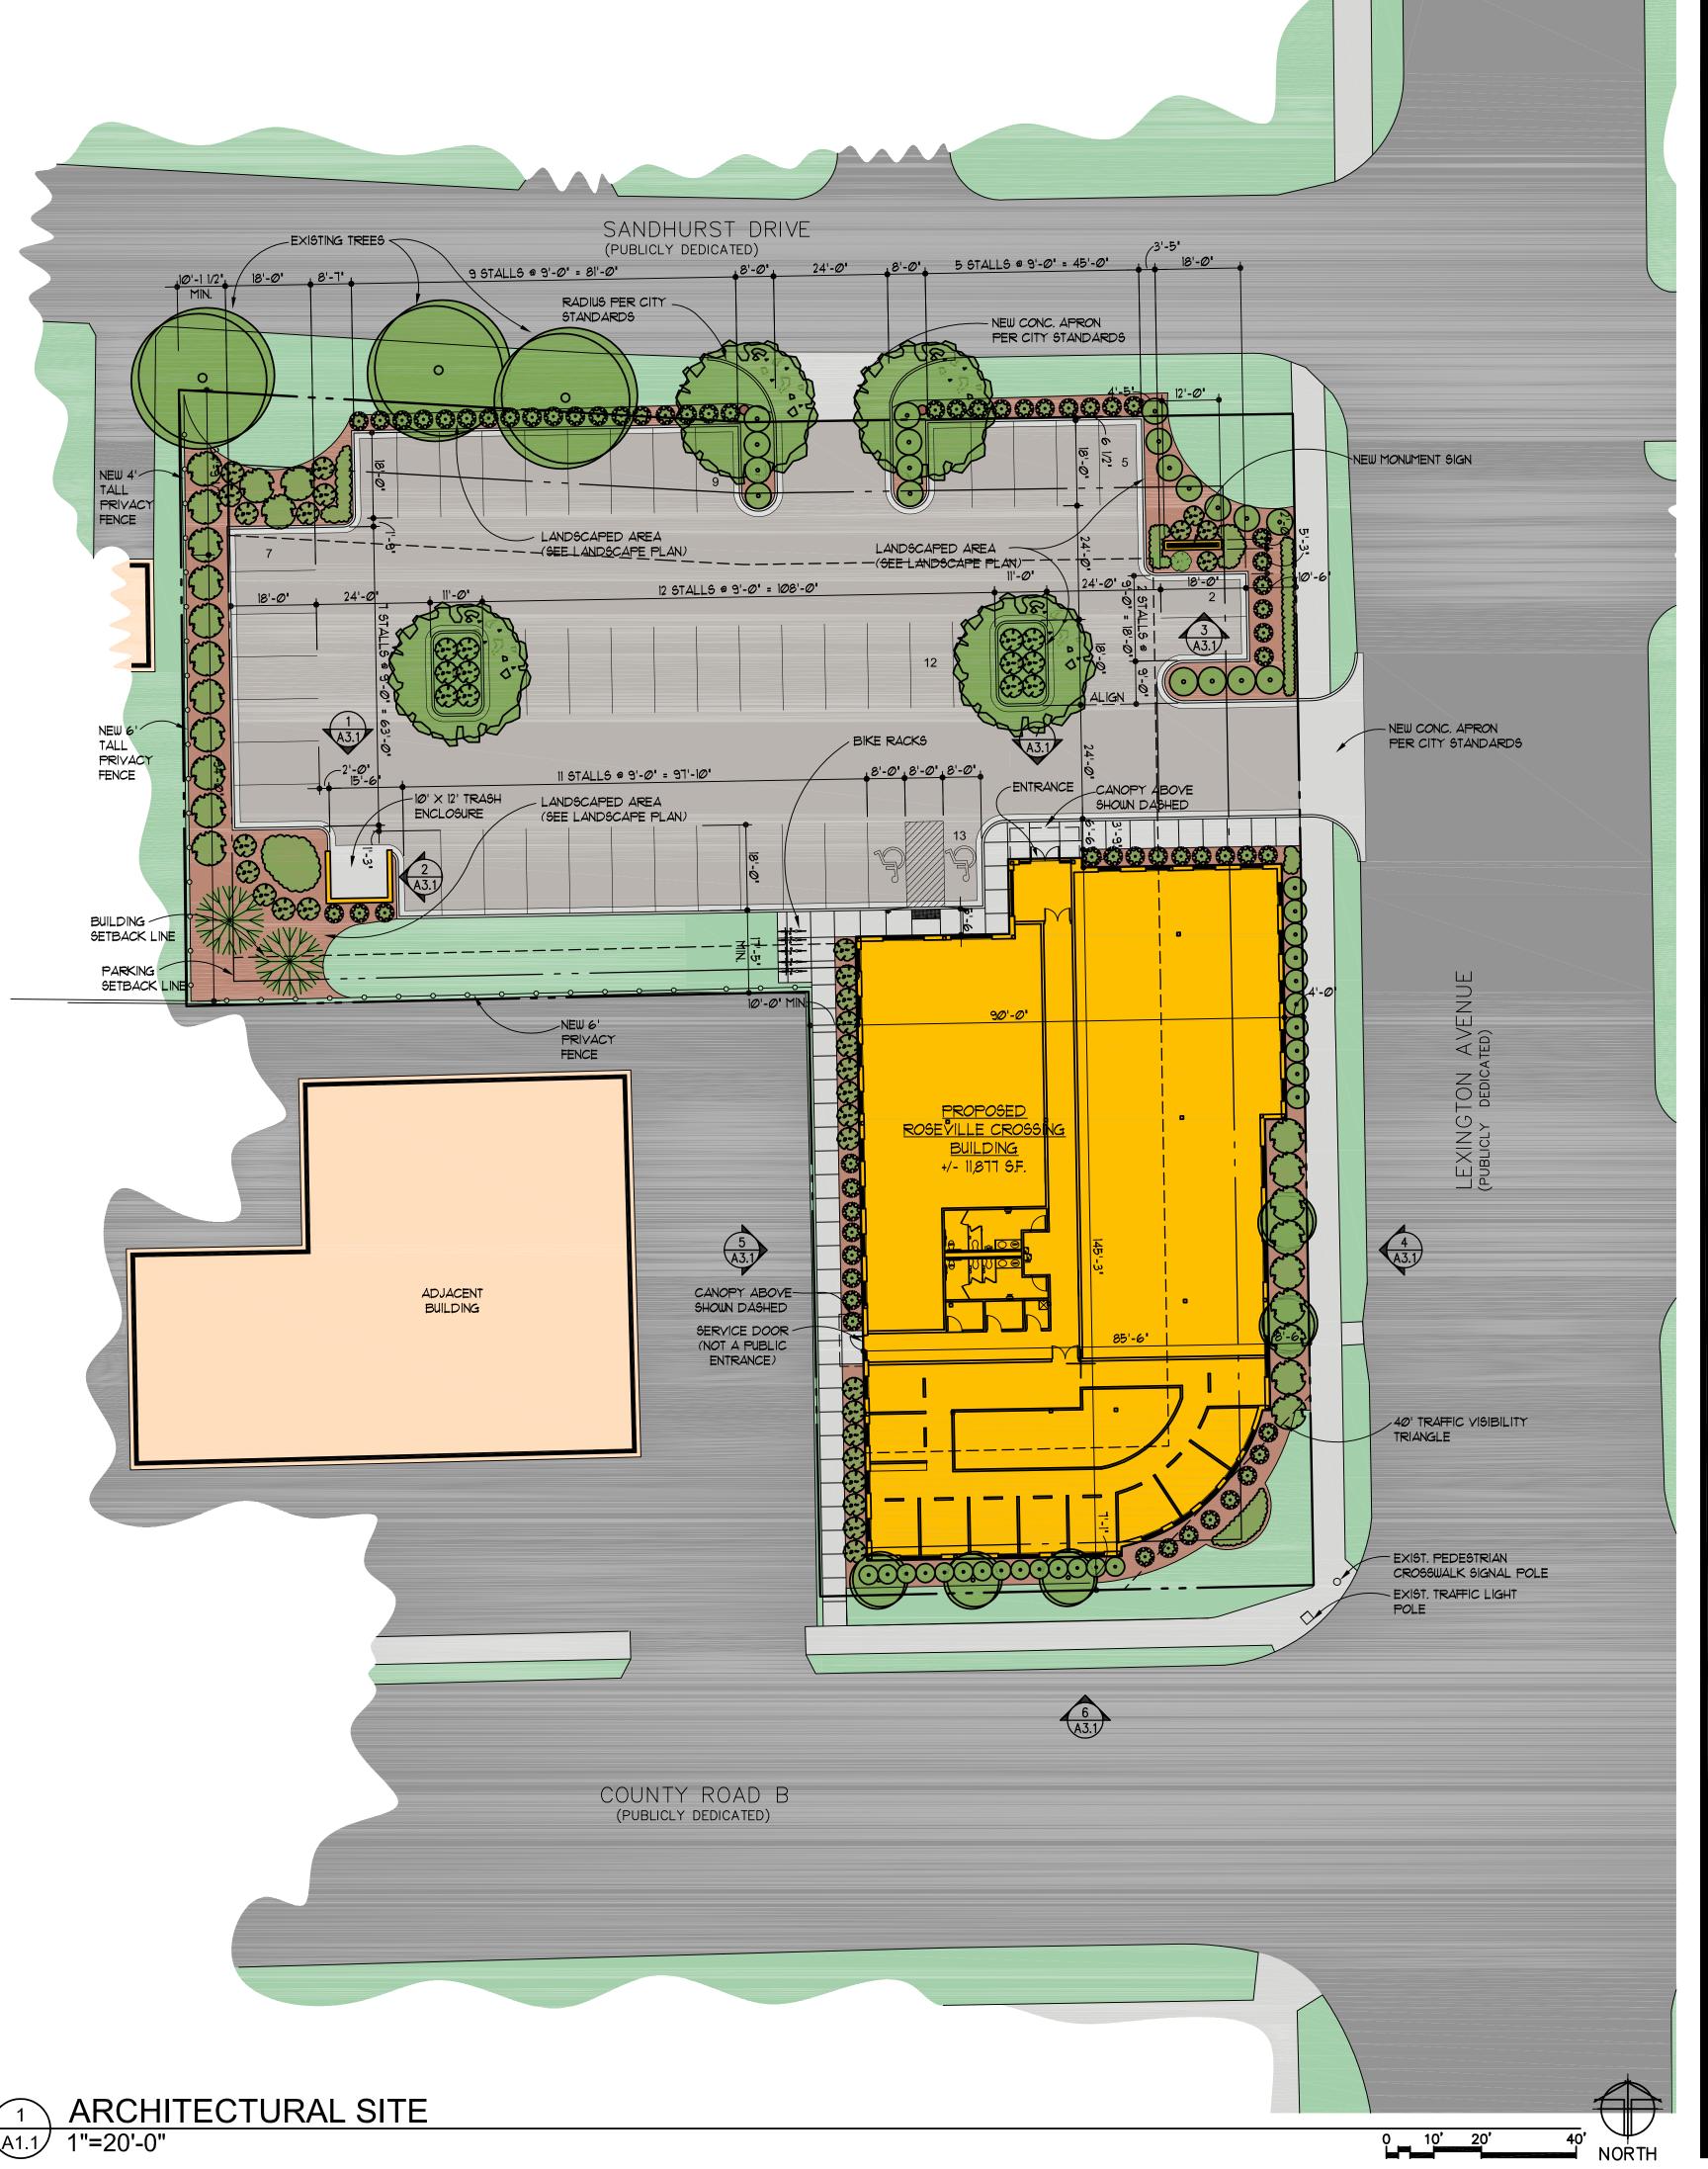

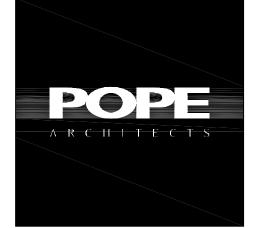

Pope Associates Inc. 1255 Energy Park Drive St. Paul, MN 55108-5118 Ph. (651) 642-9200 Fax (651) 642-1101

# Wellington MANAGEMENT, INC.

ROSEVILLE CROSSING

## ARCHITECTURAL SITE PLAN


Issues and Revisions


OWNER'S REVIEW	2-4-09
CITY SUBMITTAL	2-6-09
CITY RESUBMITTAL	2-25-09
CITY RESUBMITTAL	3-16-09
OWNER REVIEW	3-20-09
OWNER REVIEW	4-6-09
CITY RESUBMITTAL	4-9-09
CITY RESUBMITTAL	4-29-09

Commission No.	82443-07028
Drawn by	
Checked by	C

SHEET

A1.1

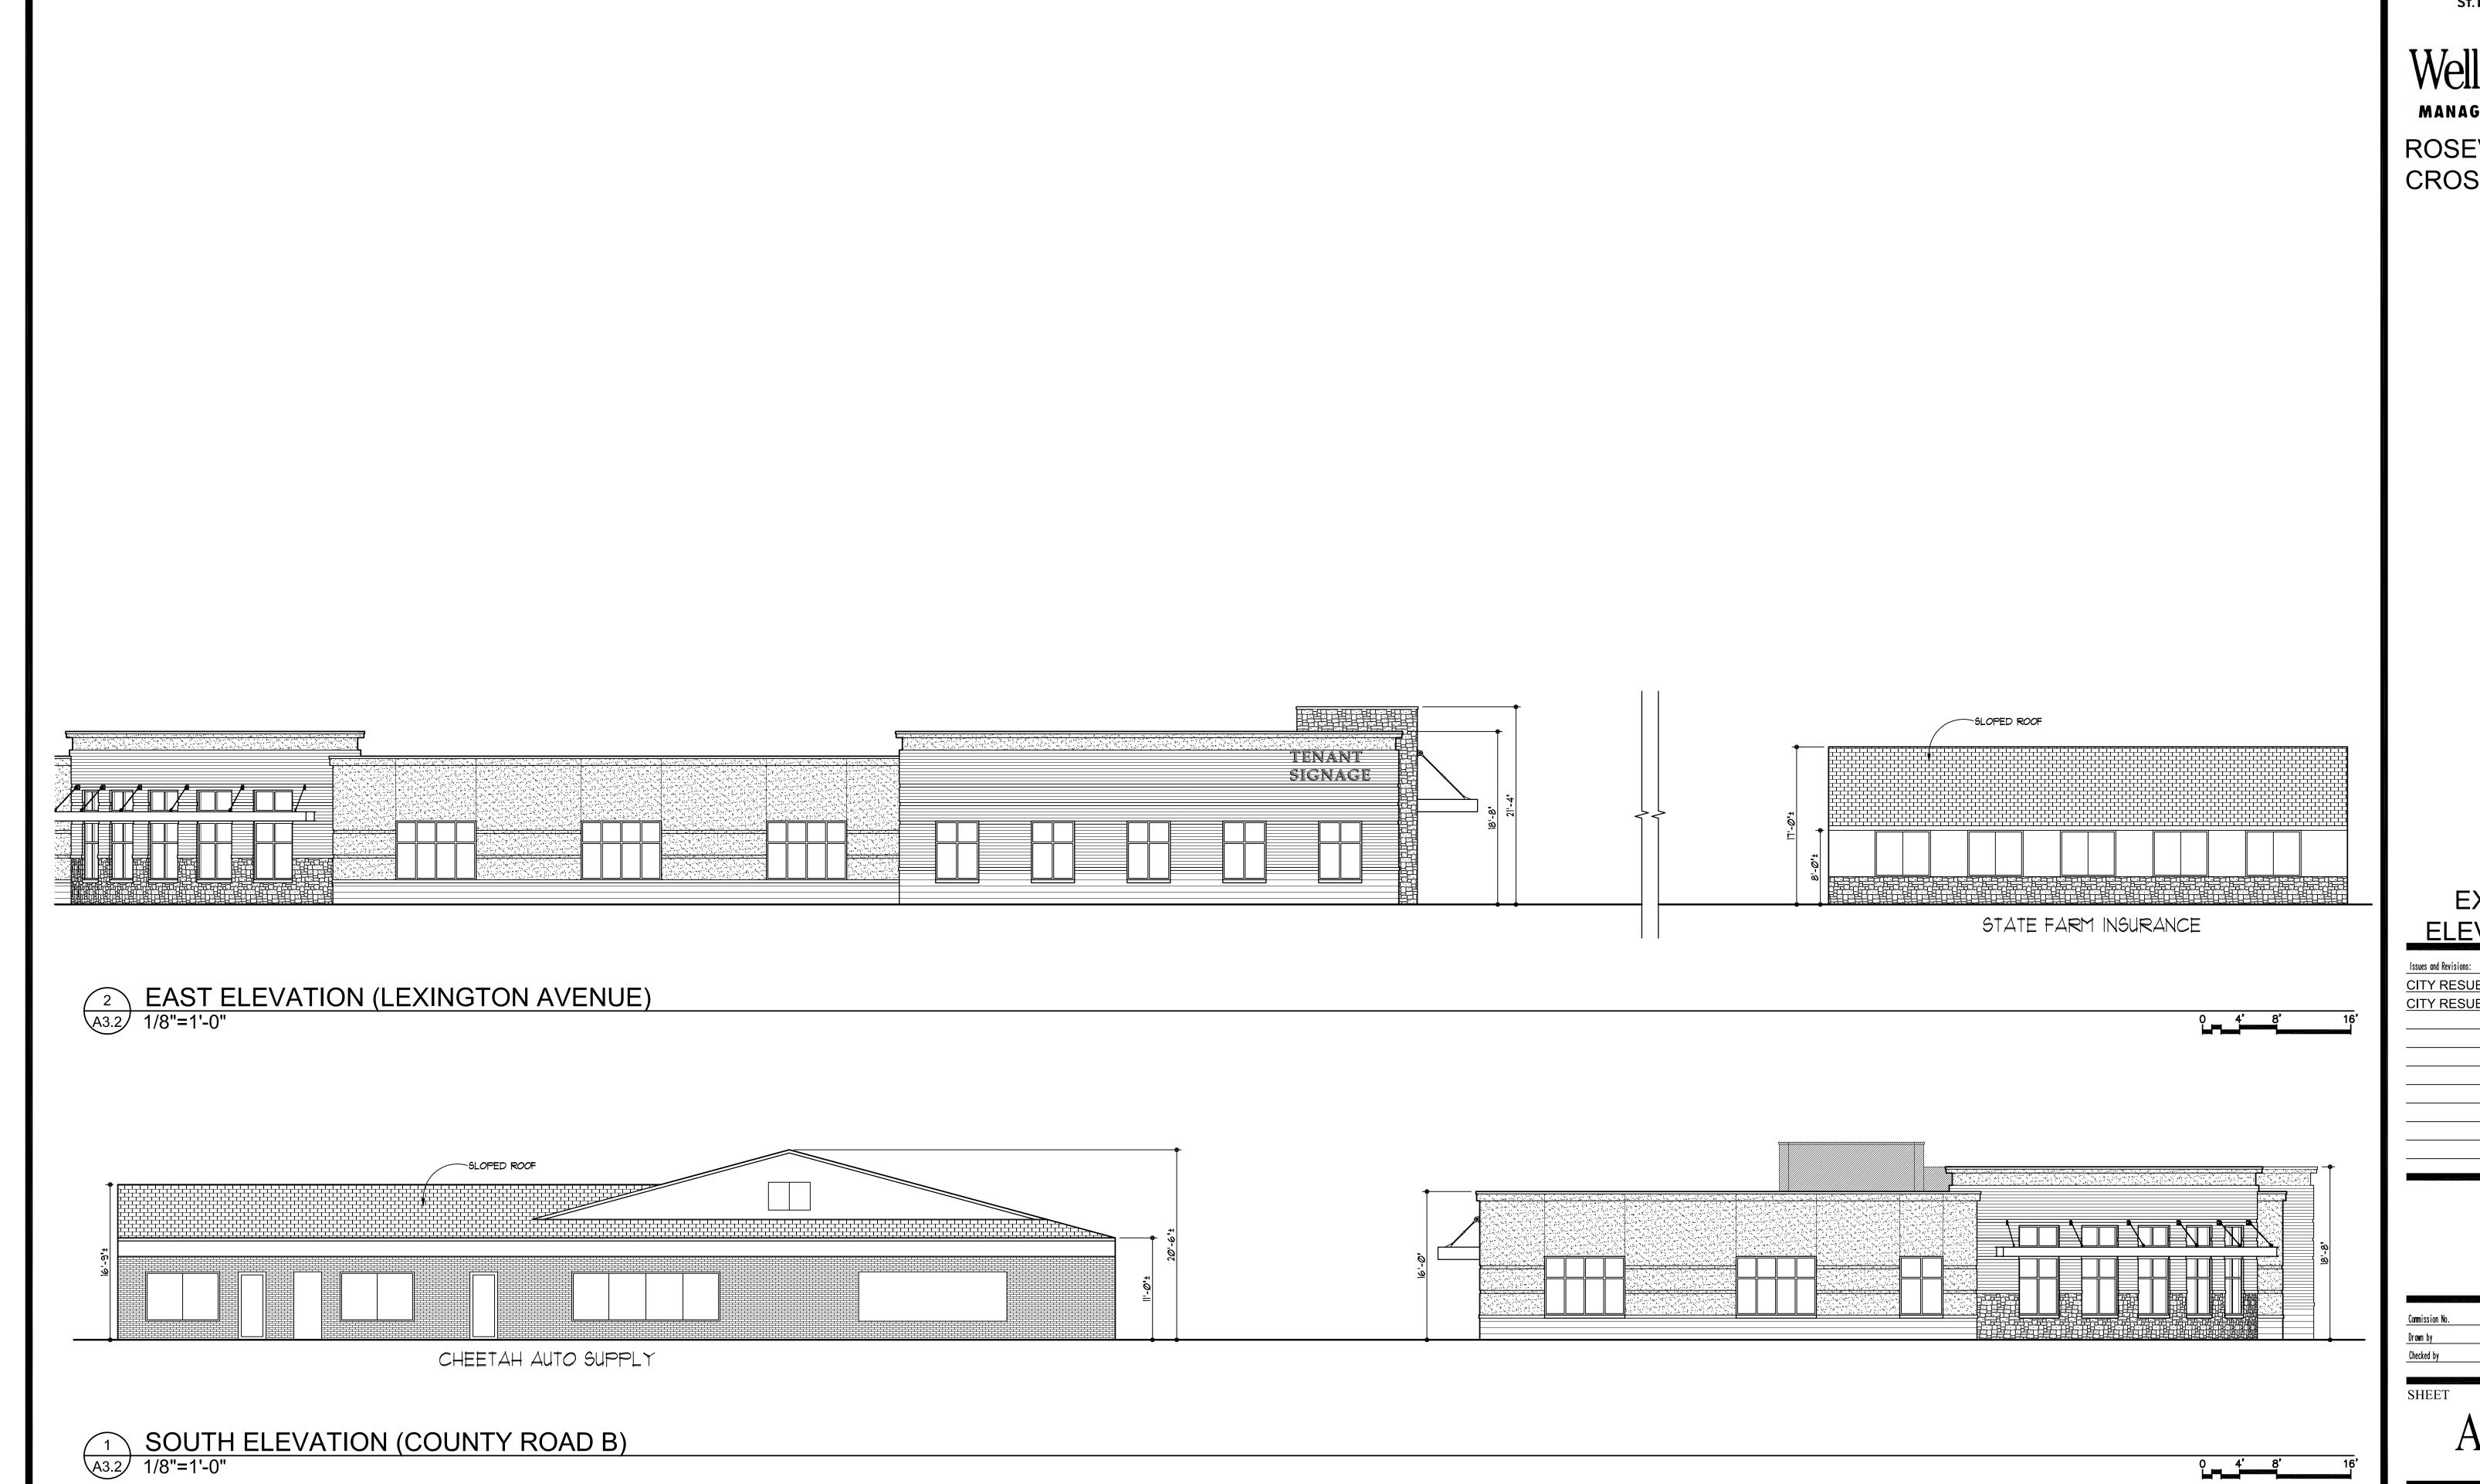

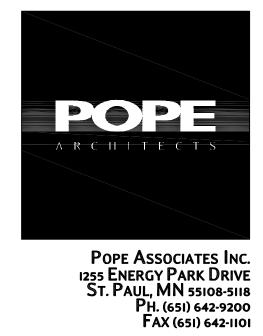

Wellington MANAGEMENT, INC.

ROSEVILLE CROSSING

> **EXTERIOR ELEVATIONS**

CITY RESUBMITTAL 4-29-09







PROJECT

Roseville Crossing Lexington & County Road B

4-22-09

82443-07028a





PROJECT

Roseville Crossing Lexington & County Road B

4-22-09

82443-07028a